

R/W

41.25'

West Clinton Street

82.5' R/W

66'

R/W

41.25'

66'

32' ±

219

REALTOR'S OFFICE

221

PROPOSED HAIR SALON  
Former Insur. Office

49'

Webster Street

229

HISTORIC HOME

16.5' ±

11'

165'

H.C. Ramp

conc. landing

conc. walk

Maintenance  
Garage  
TO REMAIN

165'

P

R/W

82.5' R/W

165'

R/W

46.5'

84' ±

Gar.

E PUBLIC ALLEY

R/W

16.5'

66'

R/W

20.7'

30.35'

20.17'

14'


66'

10'




Scale: 1"=30'


CHURCH

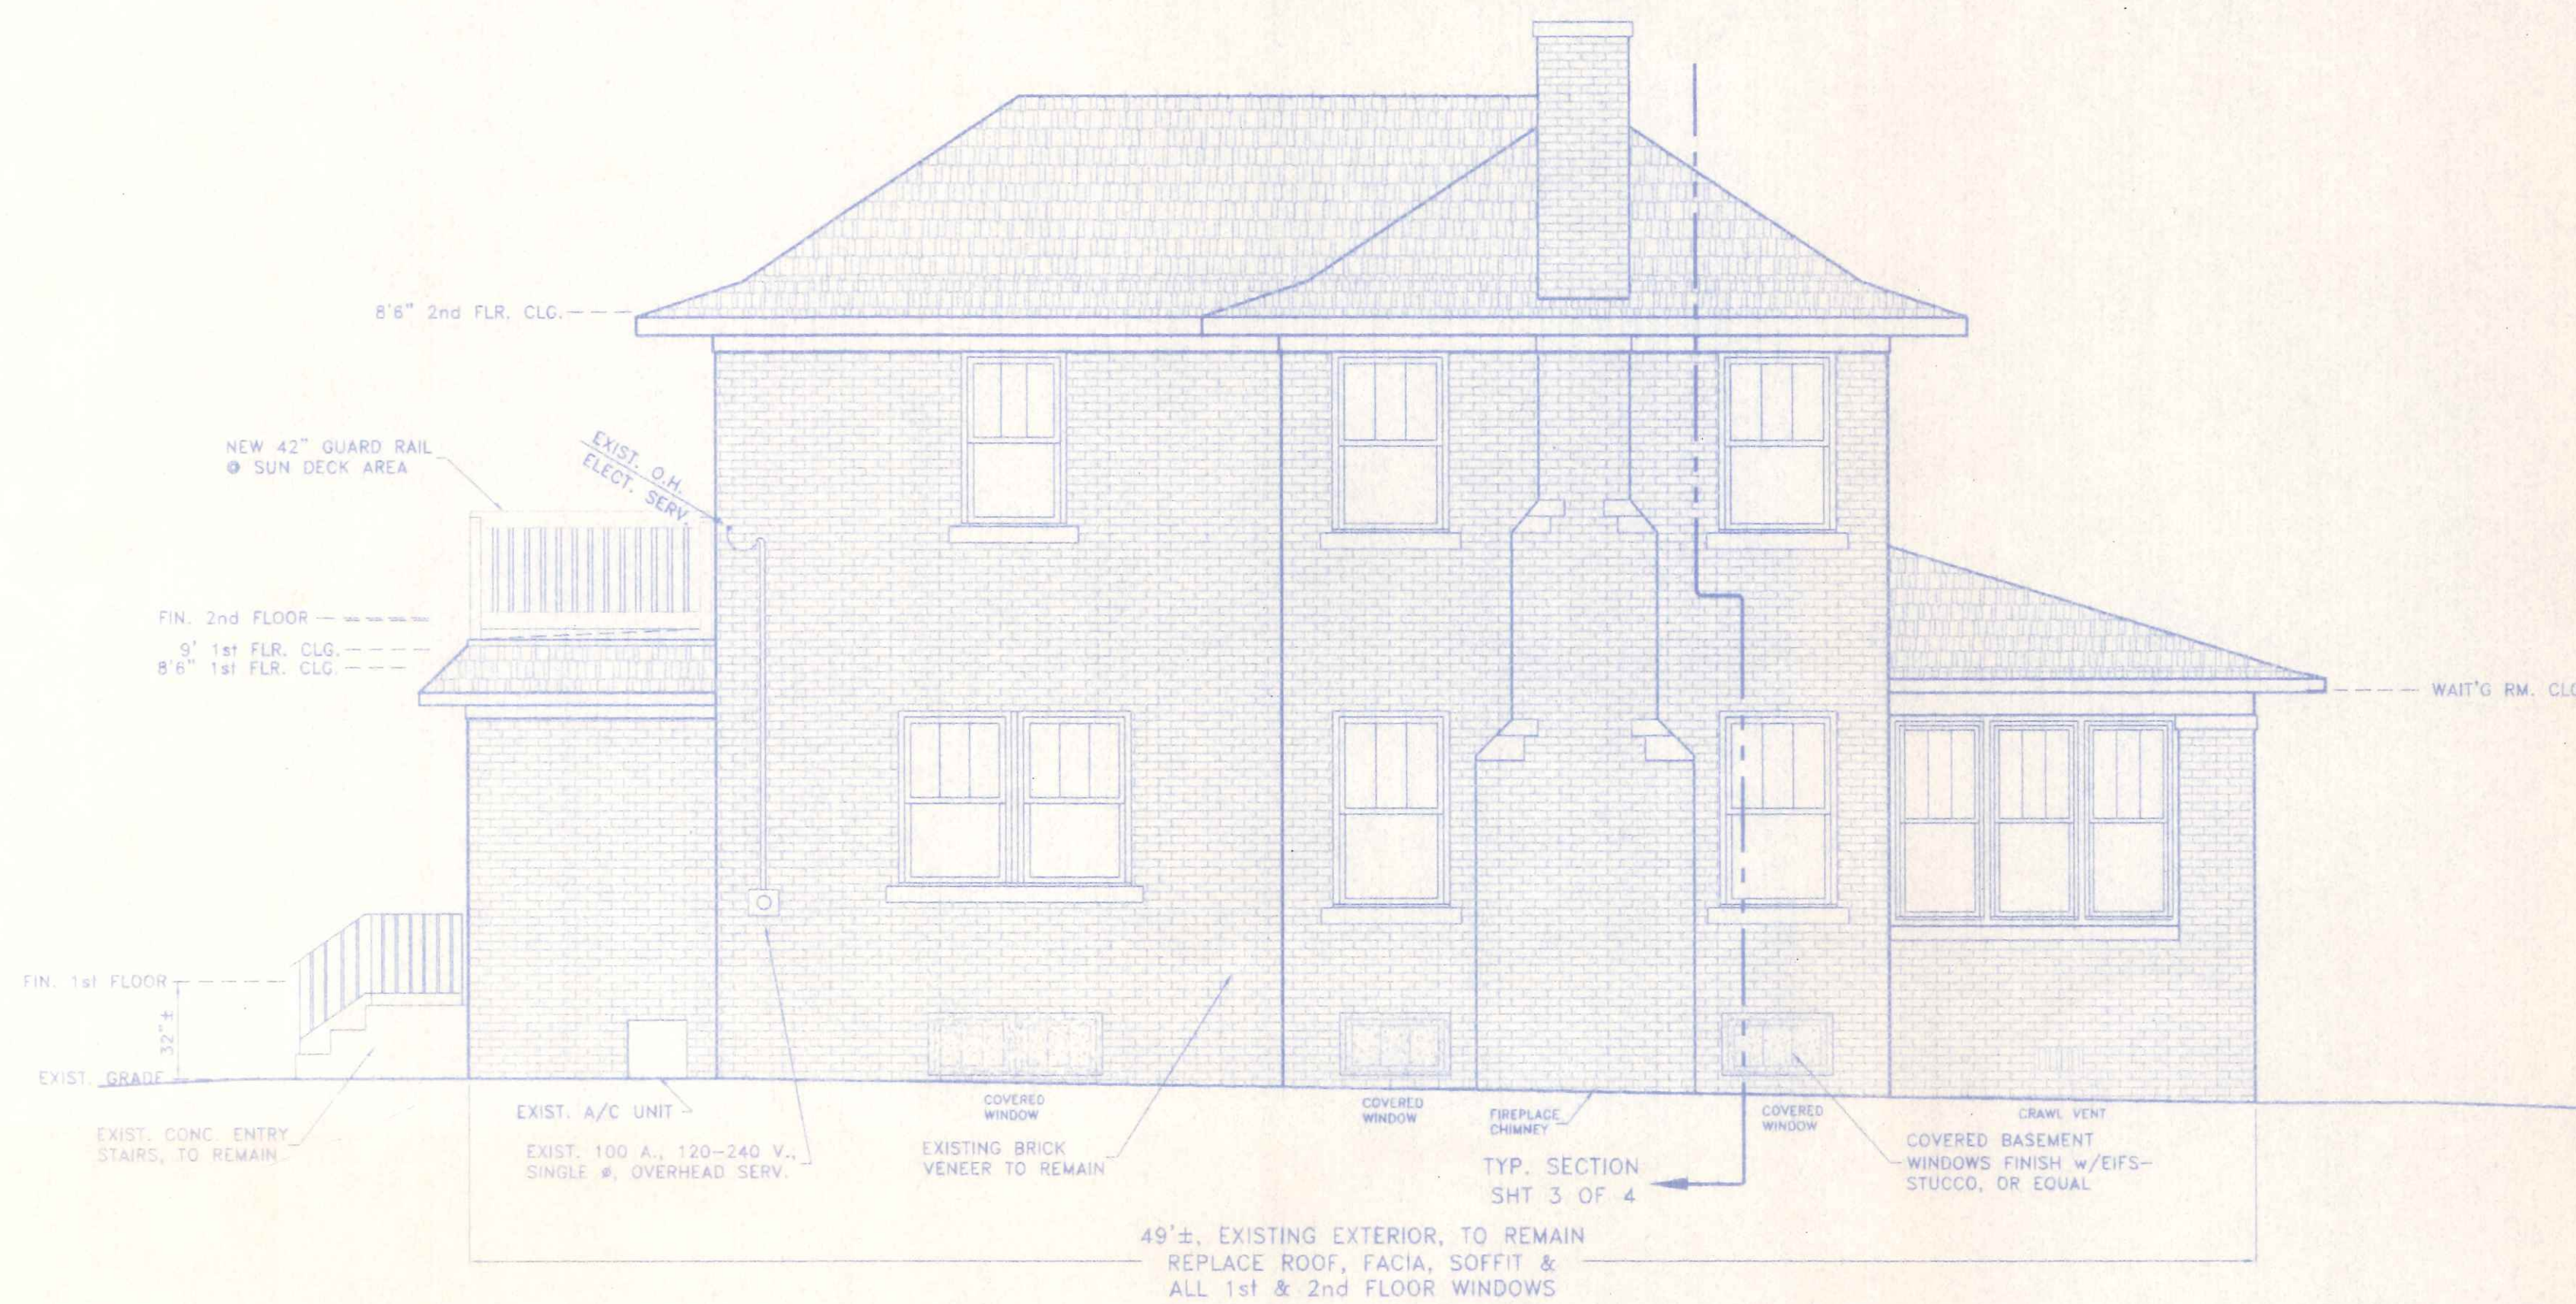


EASTERLY (Left side) ELEVATION

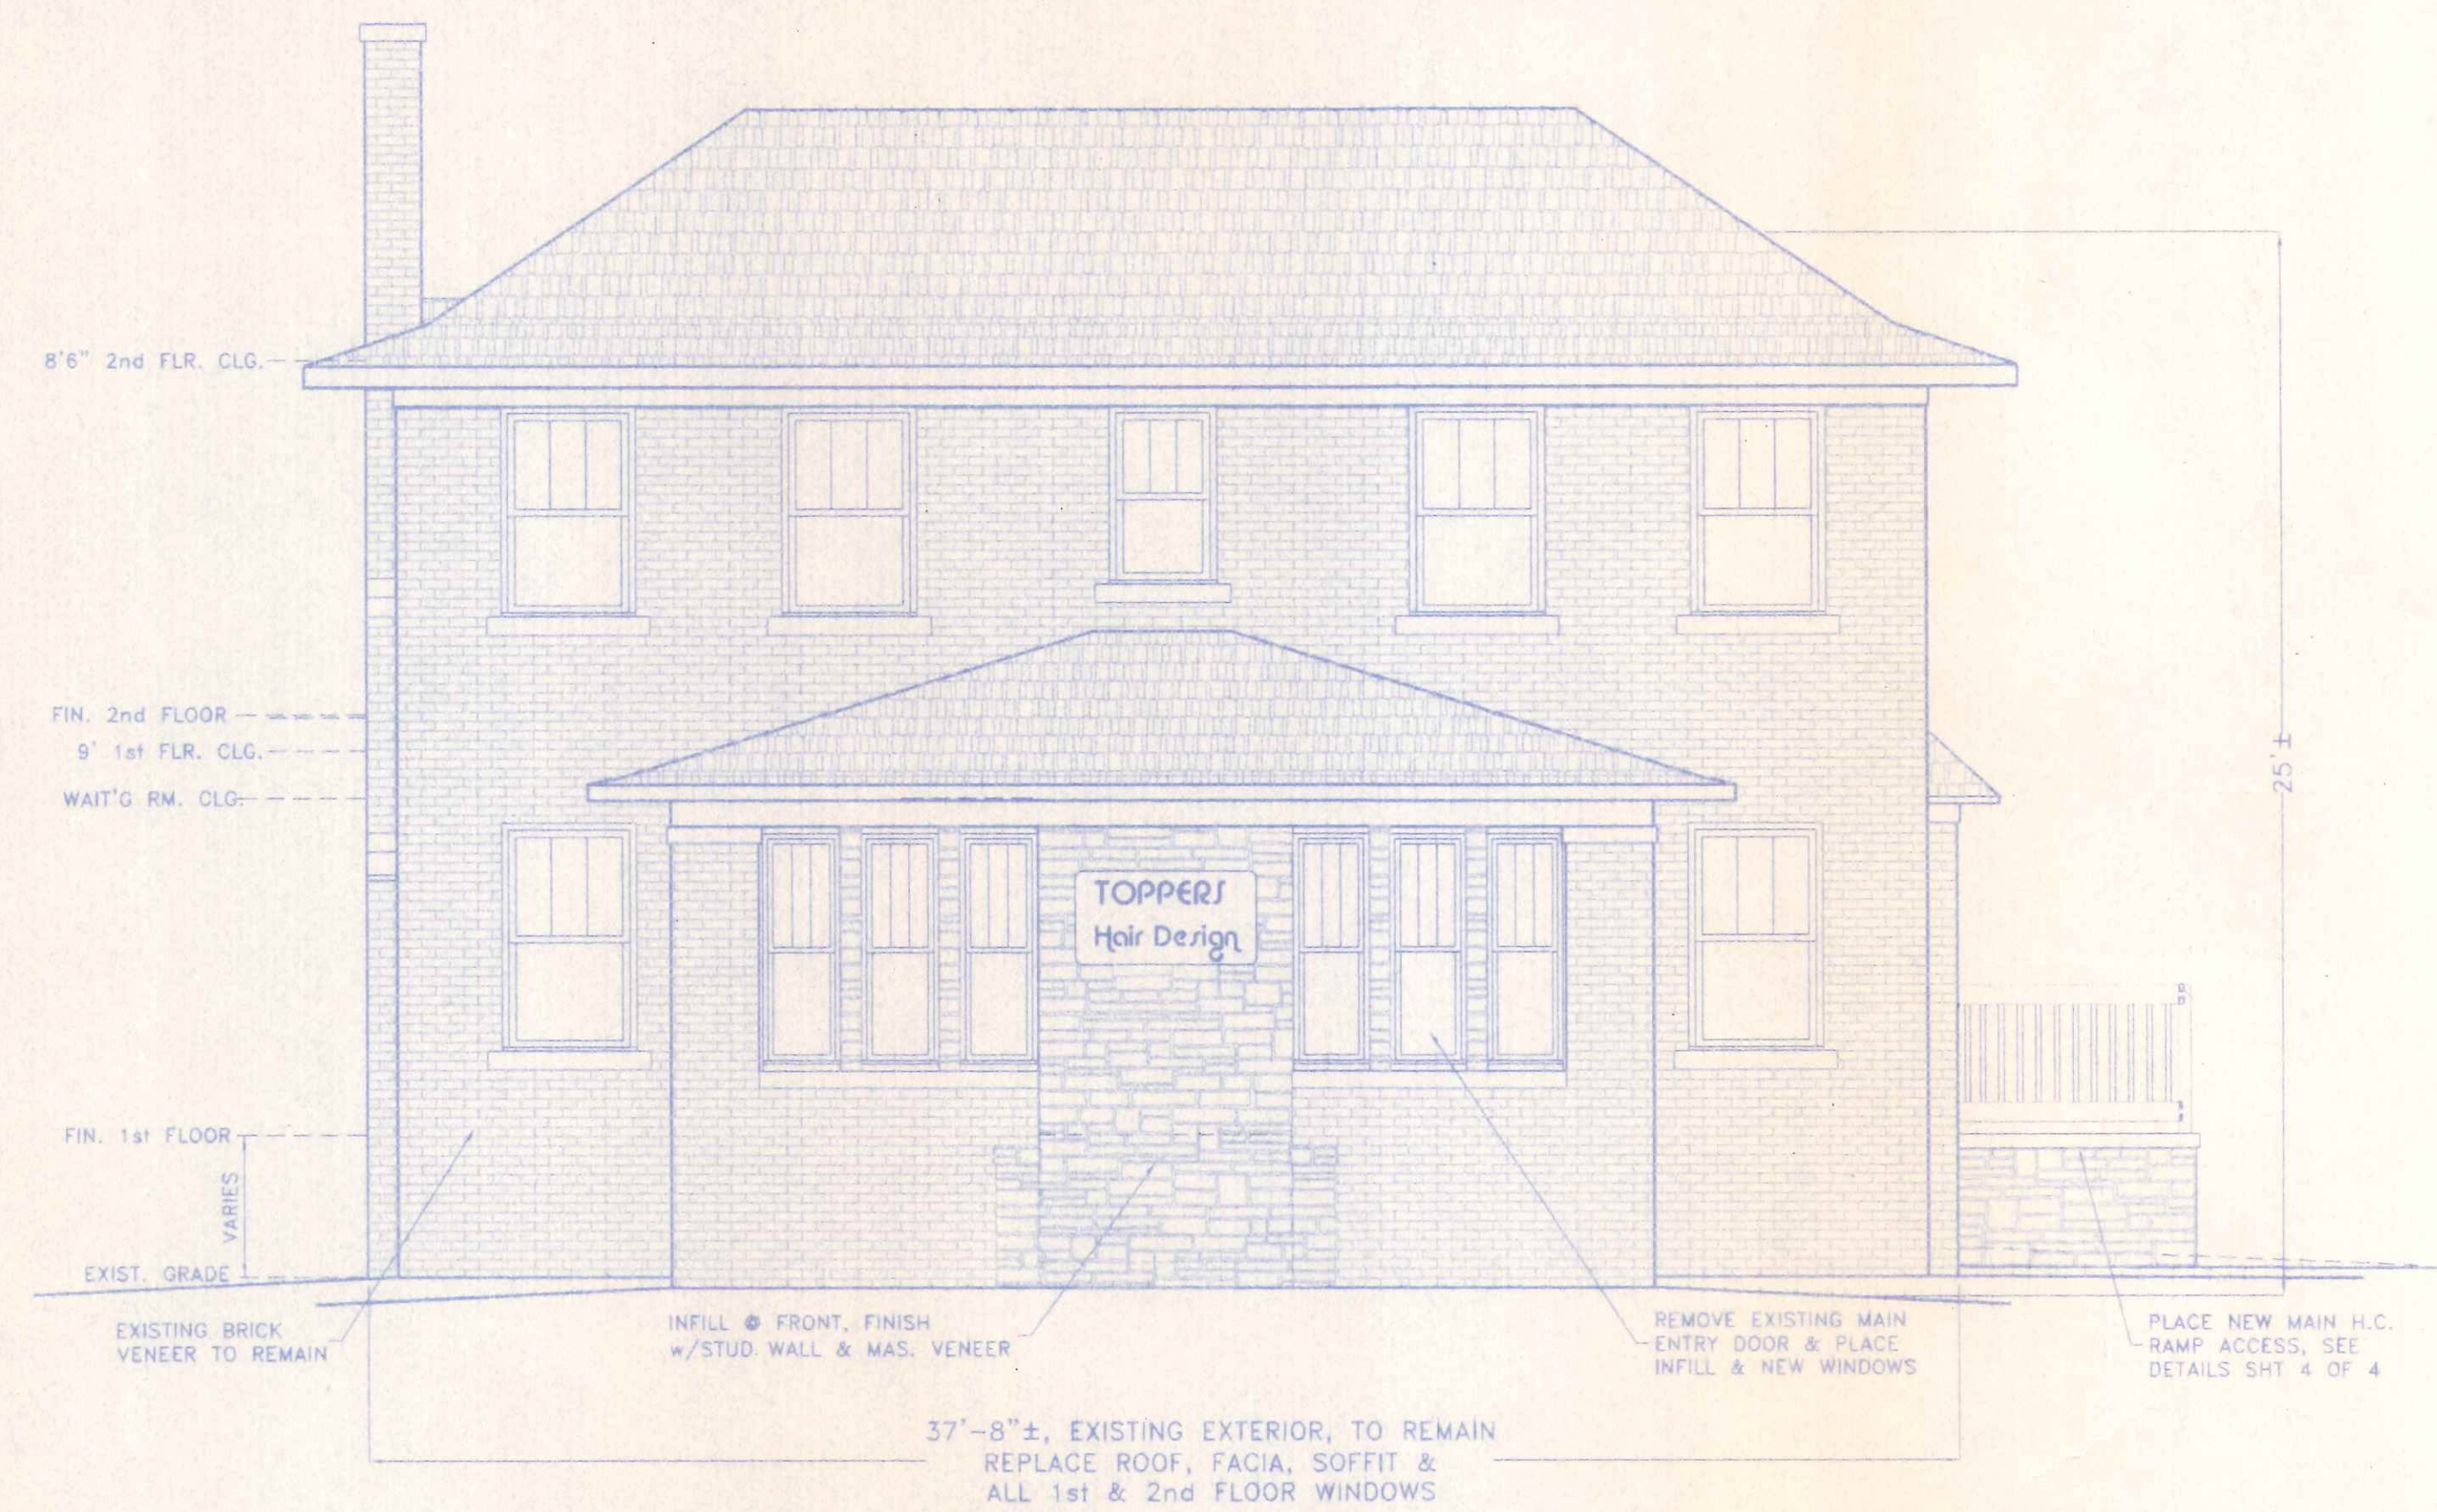

NORTHERLY (Front side) ELEVATION

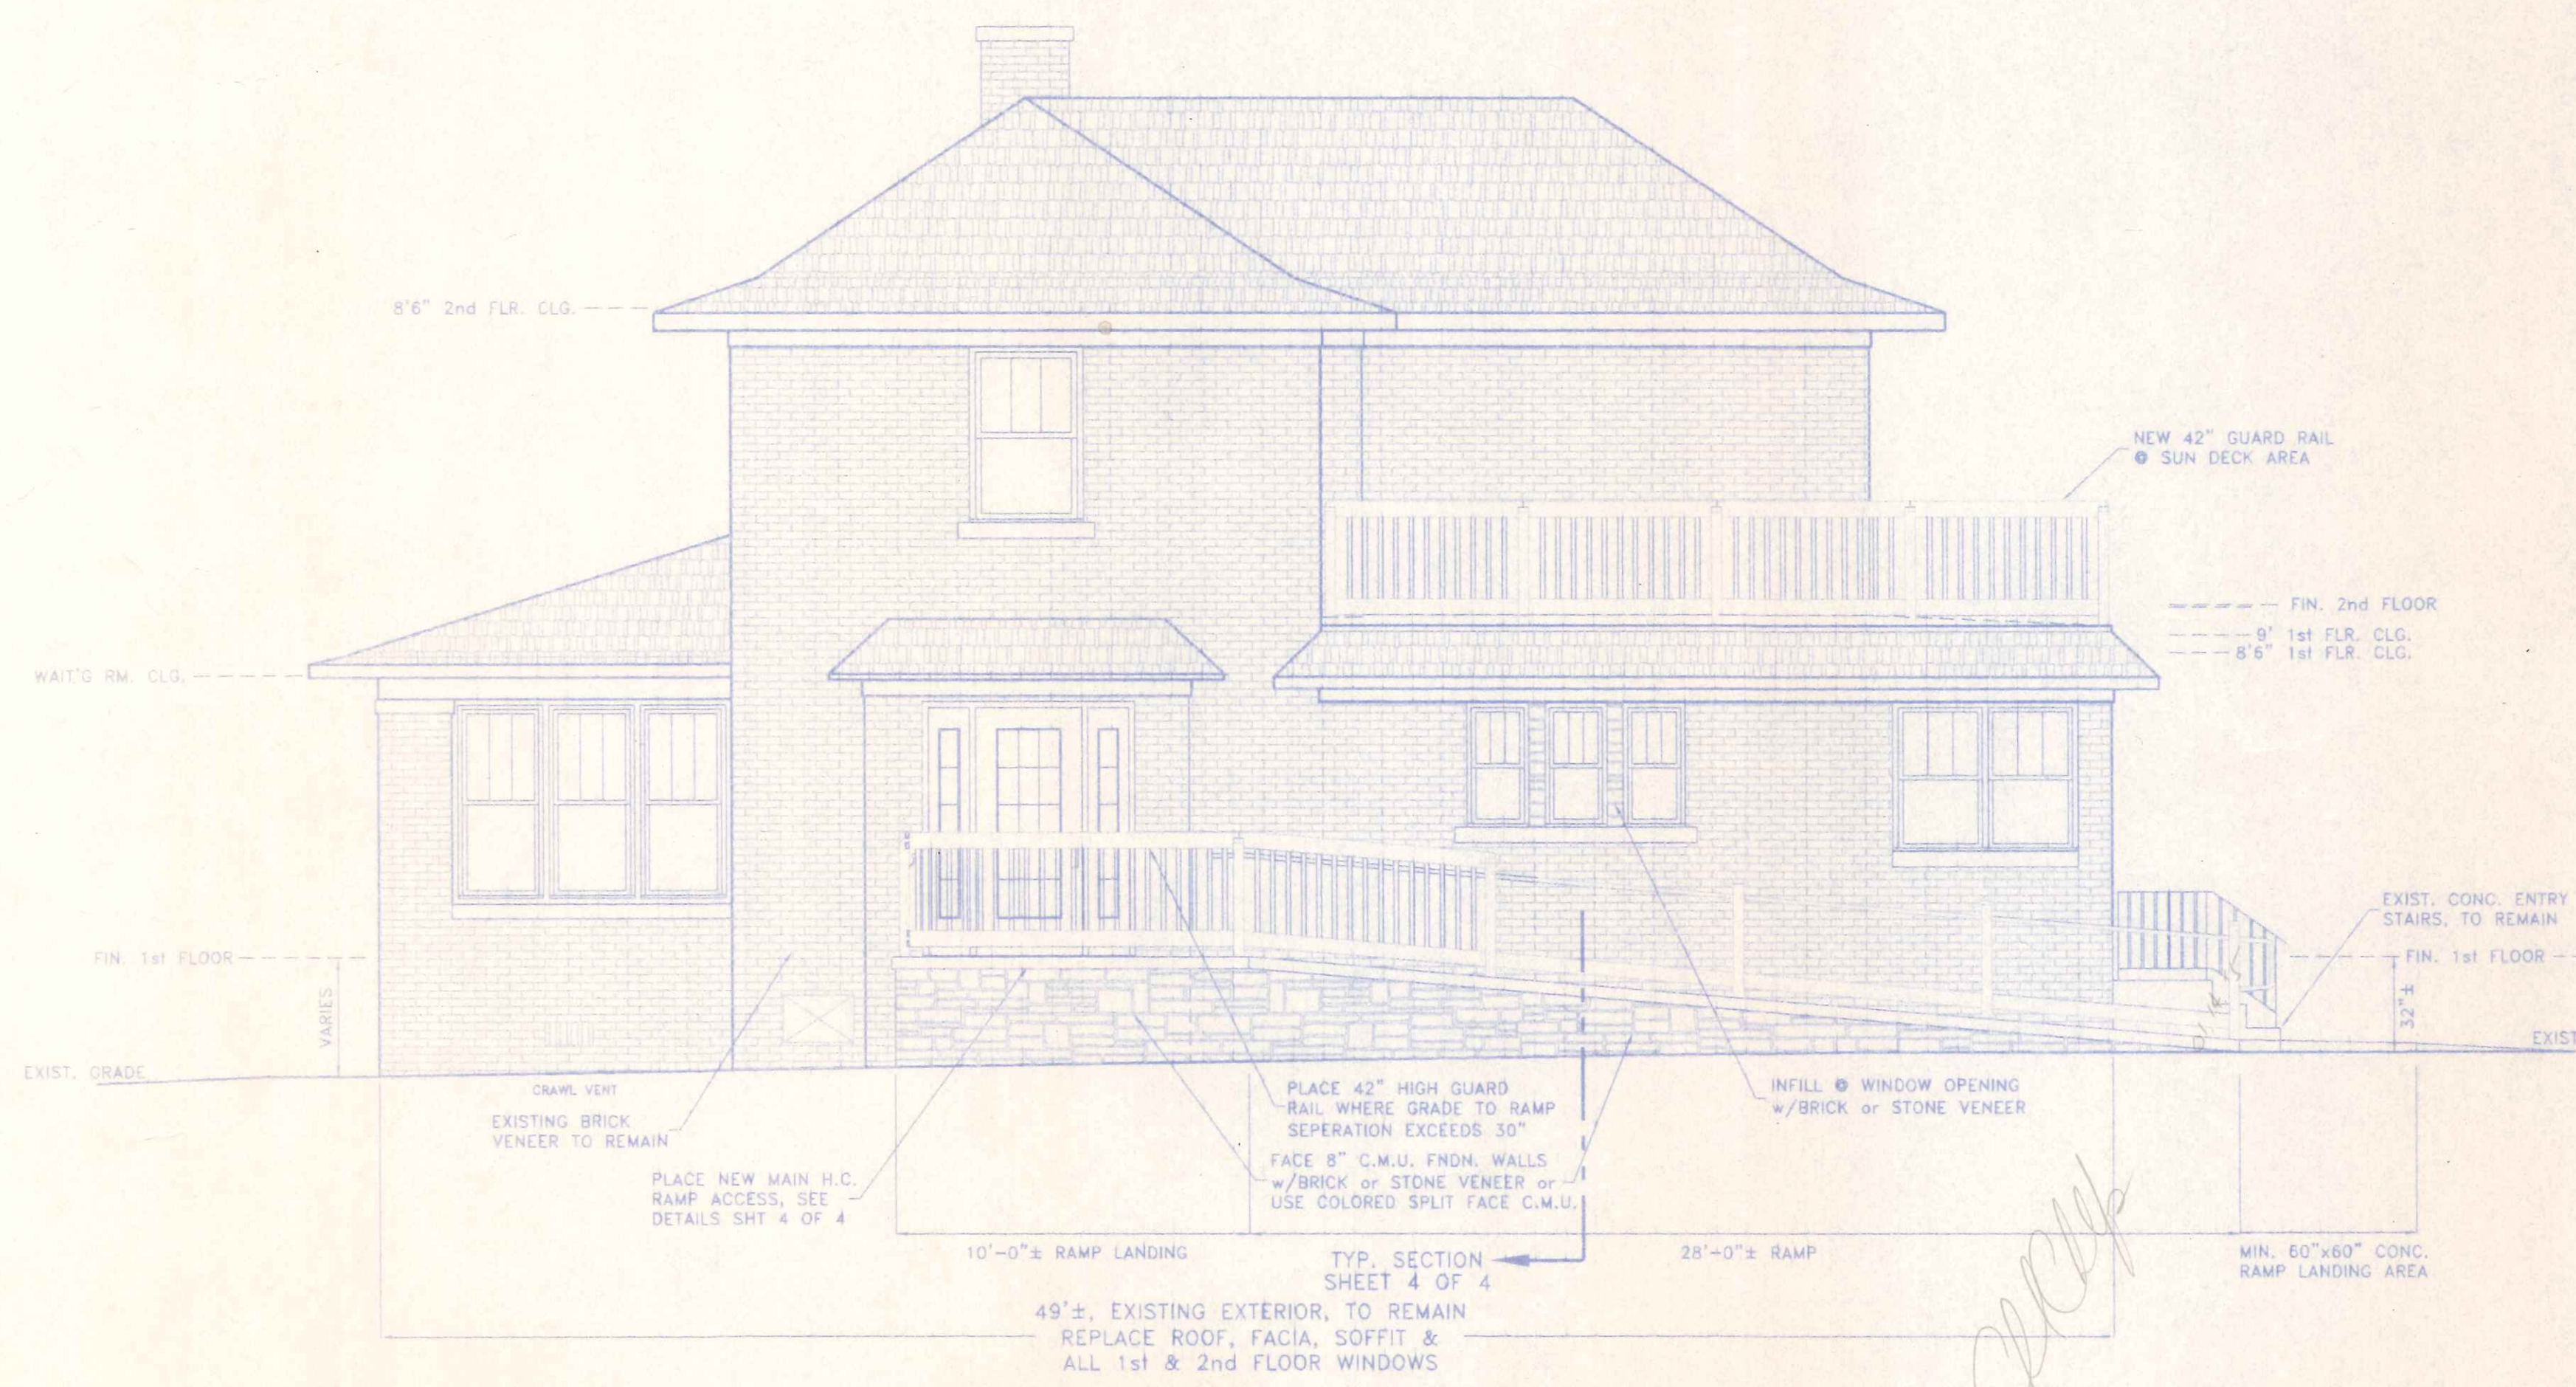


WESTERLY (Right side) ELEVATION

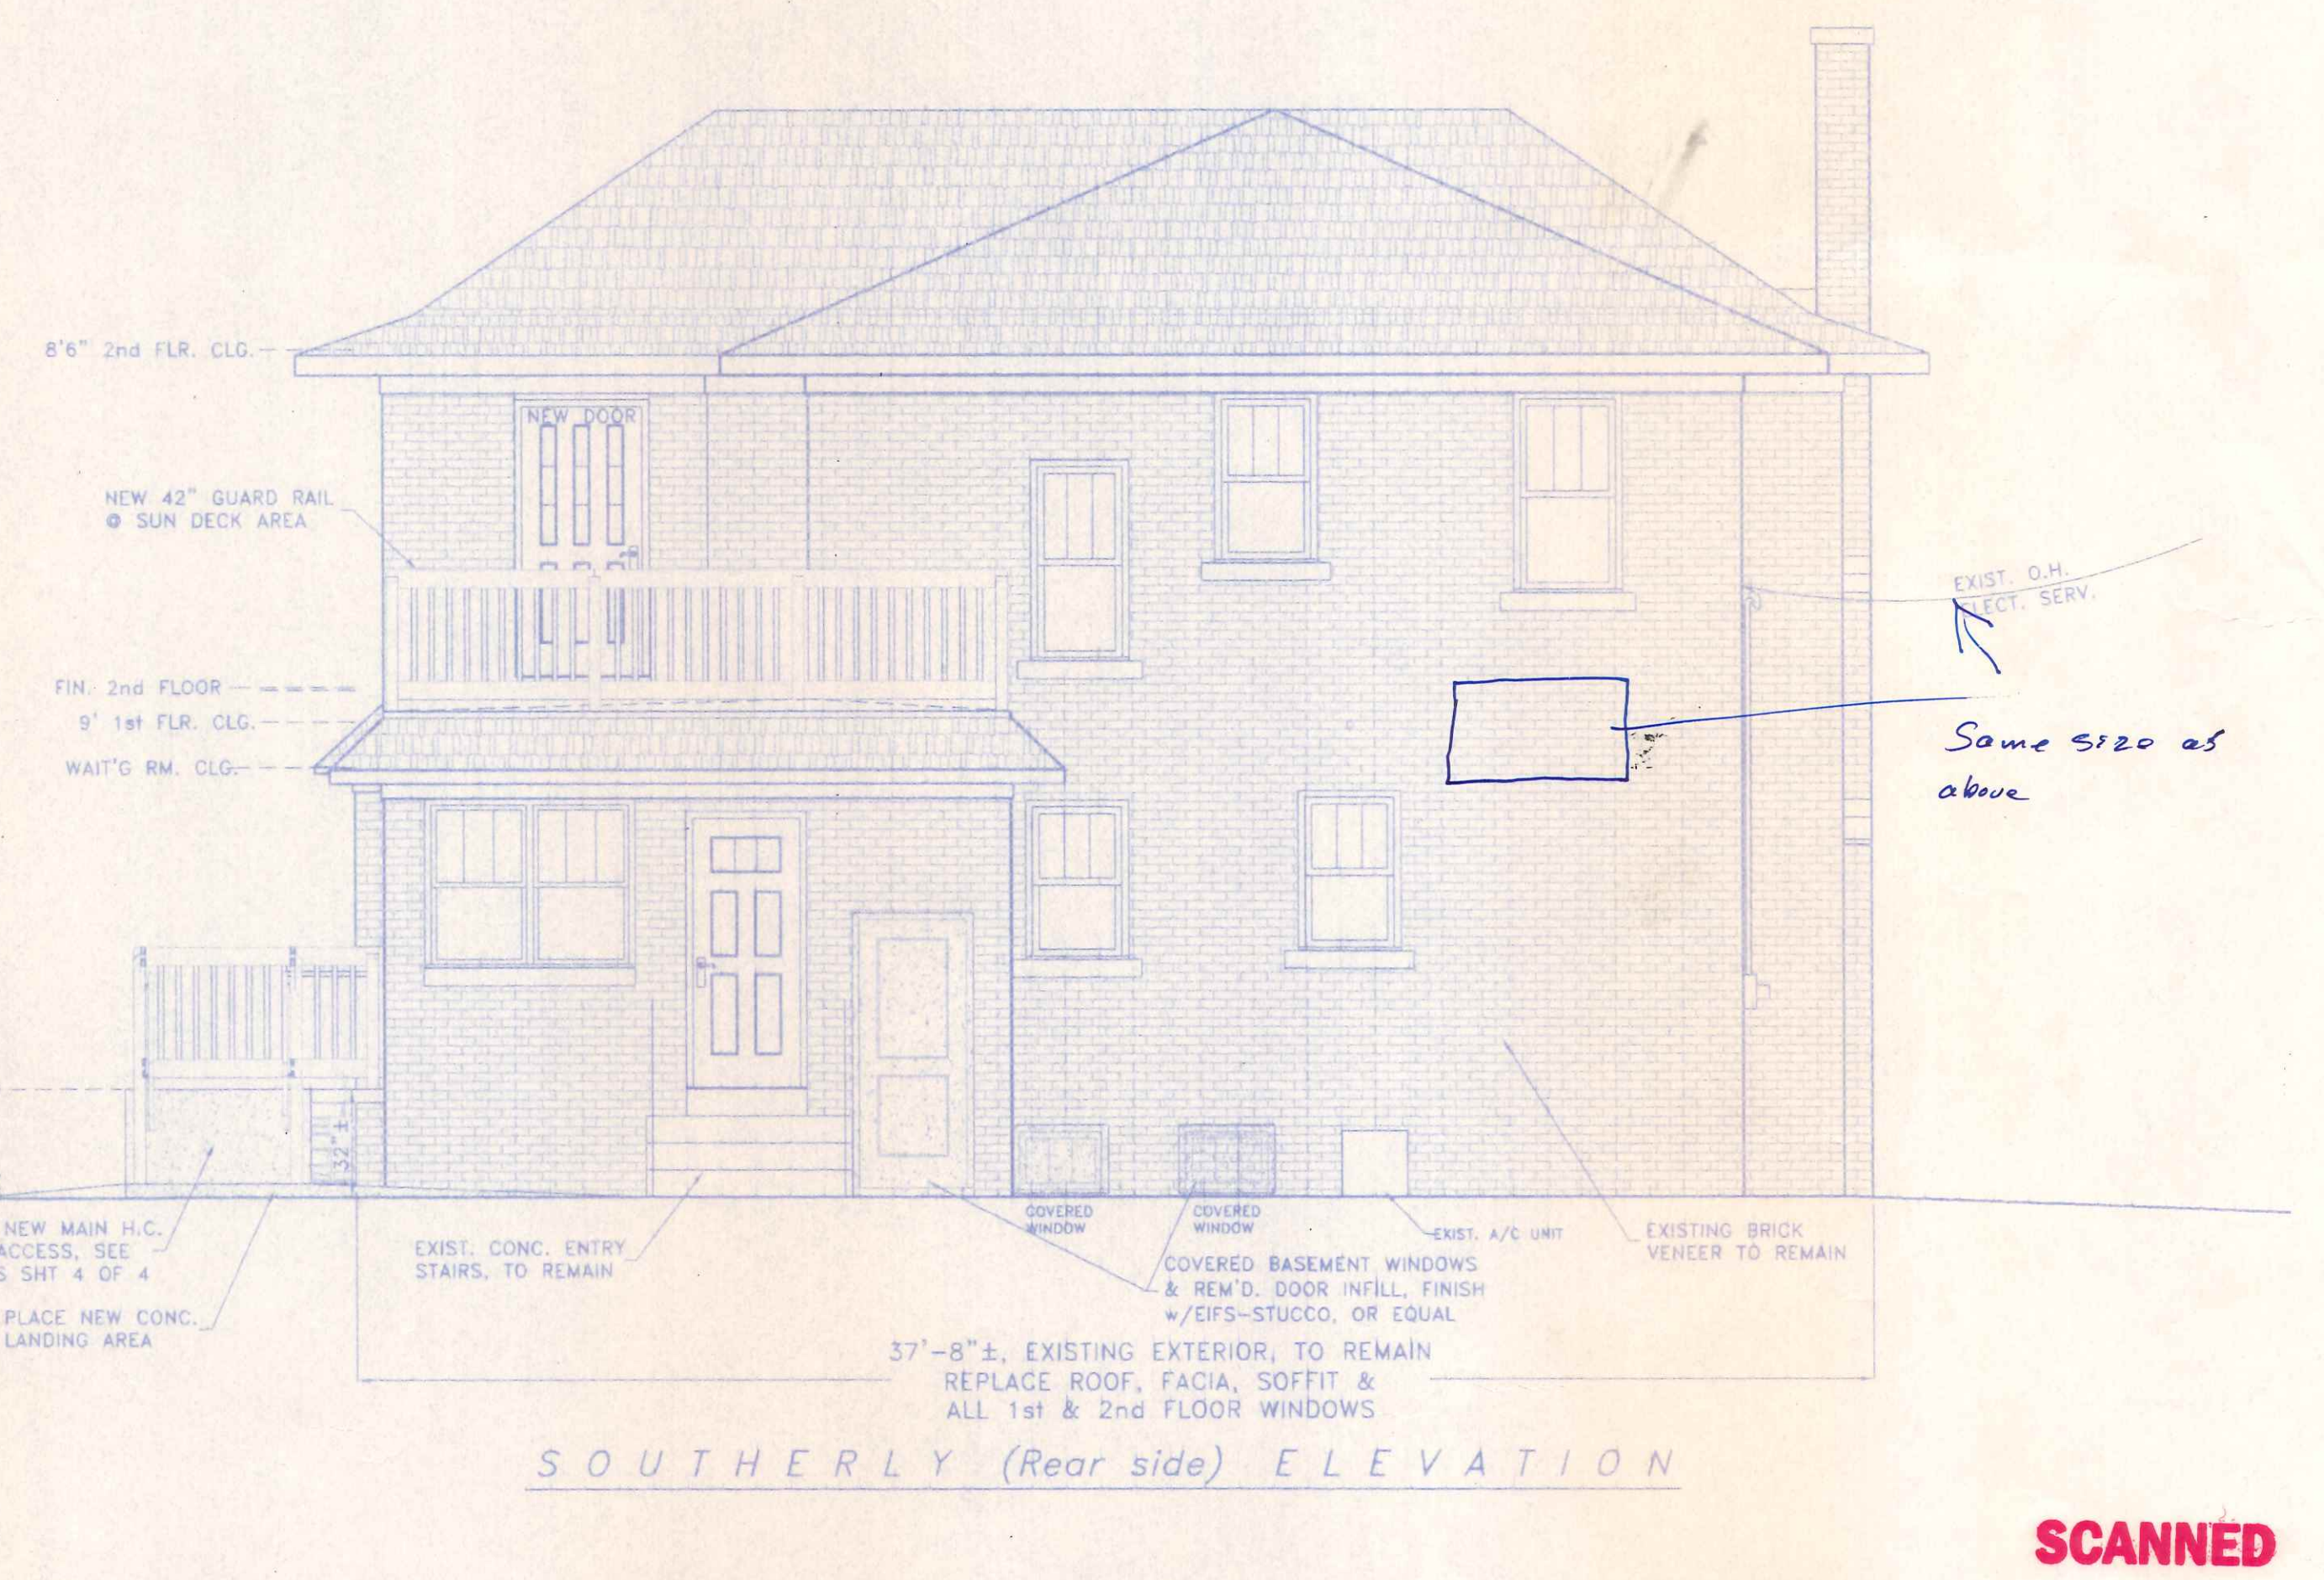

SOUTHERLY (Rear side) ELEVATION

- INDEX OF DRAWINGS:
- 1) EXTERIOR ELEVATIONS & INDEX OF SHEETS
  - 2) FIRST & SECOND FLOOR PLANS & FINISH SCHEDULES
  - 3) GENERAL SPECIFICATIONS, BASEMENT PLAN & TYPICAL CROSS SECTION
  - 4) DETAILS; STAIRWAY & HANDICAPPED RAMP, ELECTRIC & WATER SERVICE, DETAILS
- ATTACHMENTS:  
 SITE PLAN  
 CITY OF NAPOLEON ZONING APPROVAL

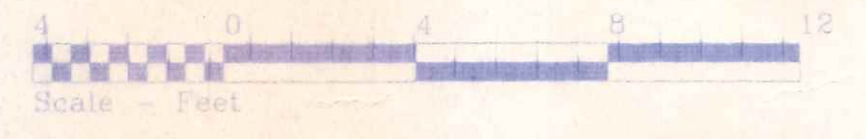

<b>TOPPER'S SALON &amp; SPA</b>	
221 W. CLINTON ST. #111 NAPOLEON, OHIO 419.438.7864	REVISED:
DIRECTORY: C:\ND\CUSTOM\DAMIAN SALON FILE NAME: FURELEV	SCALE: 1/4"=1'-0"
DRAWN BY: R.D.S. - dba: NEW DIMENSIONS	DATE: JULY 2016
BUILDING ALTERATIONS	DRAWING NUMBER: 1 of 4
EXTERIOR ELEVATIONS & INDEX	


SCANNED

ZC 2000-7

ACCESSORY & SIGN SCHEDULE(a)

ITEM	NO. REQ'D	DESCRIPTION
SIGN (RESTROOM)	2	8"x12"(min) PLASTIC LAMINATE WITH CONTRASTING SYMBOL & LETTERS AND ADHESIVE BACKING.
SIGN (H.C. PARKING)	2	8"x12"(min) PLASTIC LAMINATE WITH CONTRASTING SYMBOL & LETTERS AND ADHESIVE BACKING.
GRAB BAR	2	42" GRAB BARS 800 SERIES BRADLEE, OR EQUAL. EXPOSED MOUNTING, SAFETY GRIP FINISH.
GRAB BAR	2	36" GRAB BARS 800 SERIES BRADLEE, OR EQUAL. EXPOSED MOUNTING, SAFETY GRIP FINISH.
PAPER HOLDER	2	SINGLE ROLL TYPE, CHROME FINISH, MODEL 9890 BY SCOTT MFG., OR EQUAL.
MIRROR	2	18"x24" GLASS W/ STAINLESS STEEL FRAME MOUNT OVER LAV., BRADLEY #700, OR EQUAL.
SOAP DISPENSER	3	STAINLESS STEEL, MODEL 8562, BRADLEY, OR EQUAL. 1-EACH RESTROOM & 1 DISPENSARY
TOWEL CABINET	3	STAINLESS STEEL, MODEL 230-15, BRADLEY, OR EQUAL. 1-EACH RESTROOM & 1 DISPENSARY
MEANS OF EGRESS LIGHTING	3	DUAL HEAD EMERGENCY EGRESS LIGHTS, w/ ONE EXTERIOR REMOTE HEAD @ PUBLIC ENTRY, 90 MIN. BATTERY BACKUP, SURFACE MOUNT, CONNECT TO CIRCUIT SUPPLYING POWER TO NORMAL ROOM LIGHTING, AHEAD OF ANY LOCAL SWITCHES.
FIRE EXTINGUISHER	2	20# ABC FIRE EXTINGUISHER, PLACE ONE ON EACH FLOOR, VERIFY SIZE & LOCATION w/ LOCAL FIRE OFFICIAL

(a) RESTROOM ACCESSORIES TO BE COMMERCIAL GRADE AS MANUFACTURED BY BRADLEY, MCKINNEY, ROBRICK, SCOTT, OR EQUAL.

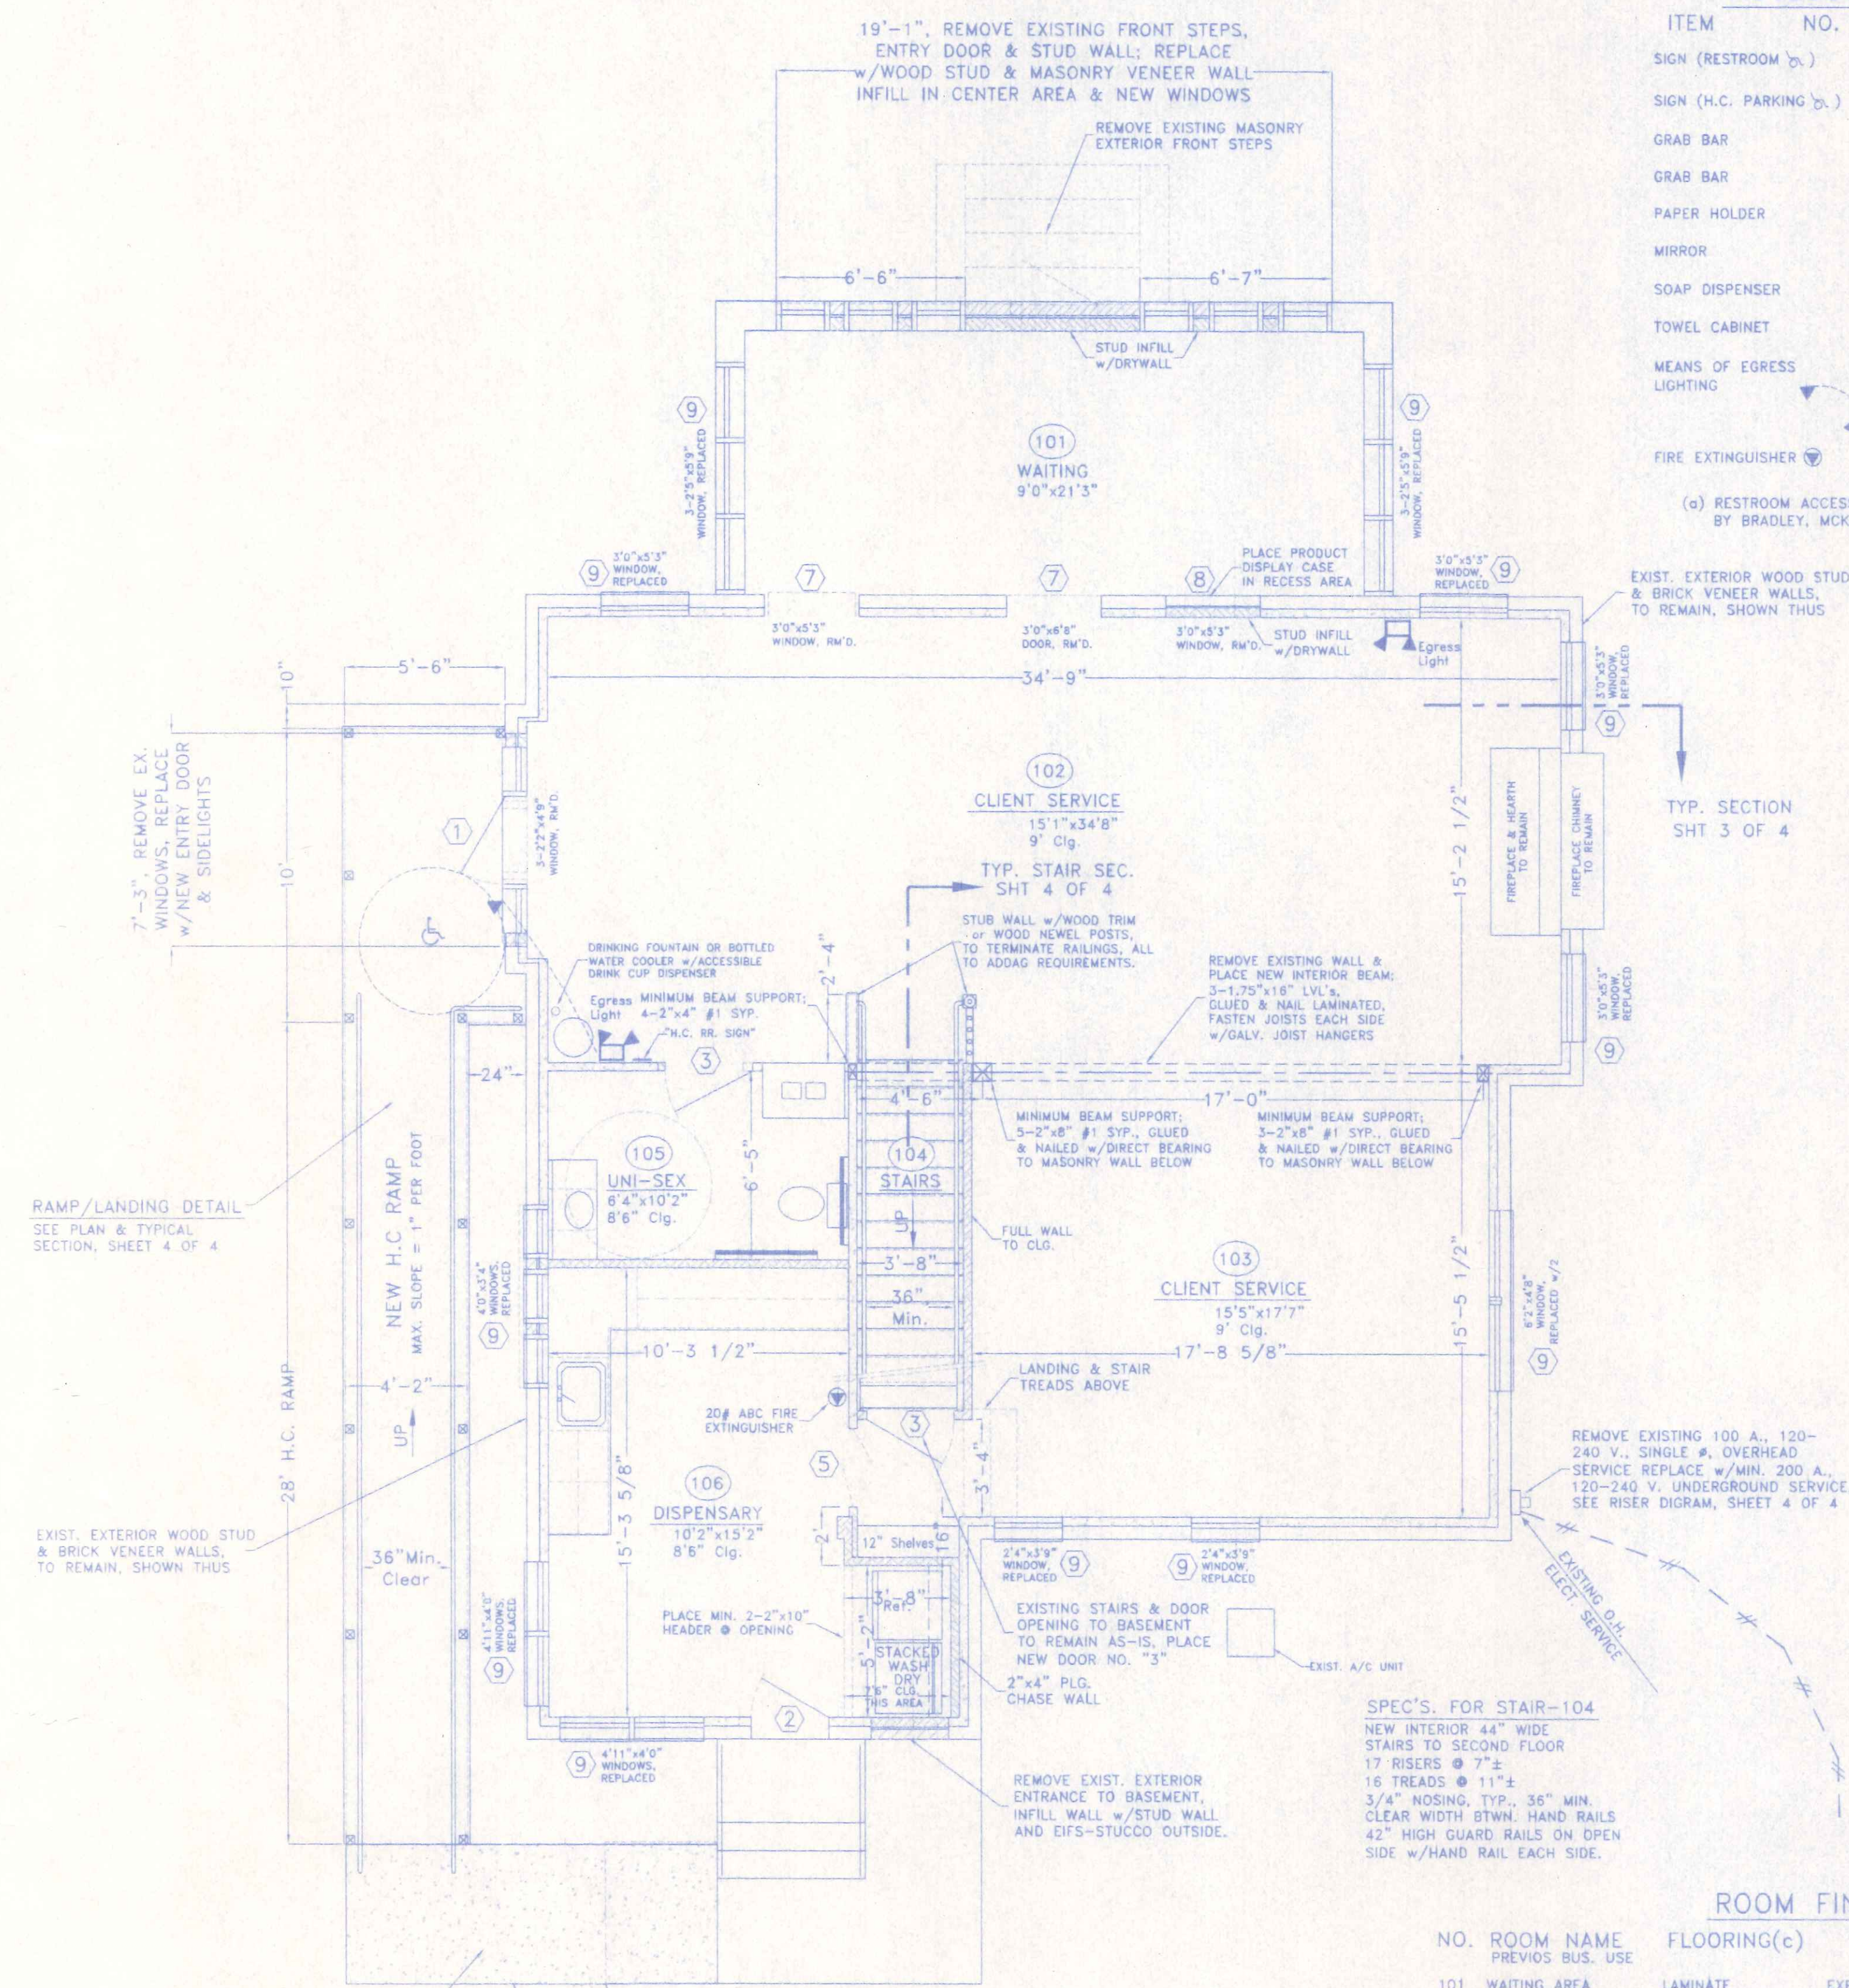

FIRST FLOOR PLAN

DOOR & WINDOW SCHEDULE


NO.	SIZE	DOOR/WINDOW	FRAME	REMARKS/HARDWARE(a)
1	3'-0"x6'-8"	NEW INSULATED METAL OR FIBER-GLASS DOOR w/2-14" SIDELITES	WOOD	PROVIDE RUSSWIN, OR EQUAL, SERIES 900 "NEWPORT" ENTRY LOCKSET HARDWARE & DECORATIVE GLASS LITE.
2	2'-8"x6'-8"	NEW INSULATED METAL OR FIBER-GLASS DOOR IN EXIST. OPENING	WOOD	PROVIDE RUSSWIN, OR EQUAL, SERIES 900 "NEWPORT" ENTRY LOCKSET HARDWARE & DECORATIVE GLASS LITE.
3	3'-0"x6'-8"	NEW RAISED (6) PANEL WOOD PRE-FINISHED DOOR & FRAME	WOOD	NEW 36" DOOR AND ADD APPROVED PRIVACY LOCKSET
4	3'-0"x6'-8"	NEW INSULATED METAL OR FIBER-GLASS DOOR	WOOD	PROVIDE RUSSWIN, OR EQUAL, SERIES 900 "NEWPORT" ENTRY LOCKSET HARDWARE.
5	3'-0"x6'-8"	FRAMED OPENING w/OPTION FOR RAISED PANEL WOOD CAFE DOORS	WOOD	OPTIONAL: PLACE DOUBLE ACTION, 42"± HIGH, RAISED PANEL CAFE DOORS w/ALL HARDWARE
6	3'-0"x6'-8"	NEW RAISED (6) PANEL WOOD PRE-FINISHED DOOR & FRAME	WOOD	PLACE 36" 9I-FOLD CLOSET DOOR w/ALL HARDWARE
7	3'-0"x6'-8"	FULL WIDTH FRAMED OPENING	WOOD	REMOVE EXISTING DOOR OR WINDOW AND FINISH ROUGH OPENING TO SIZE NOTED WITH DECORATIVE WOOD TRIM
8	SIZE NOTED	REMOVE EXIST. WINDOW & FRAME (b)	WOOD	INFILL SOUTH SIDE, FINISH NORTH SIDE FOR PRODUCT DISPLAY CASE OR MAGAZINE RACK
9	VARIES	EXIST. WINDOW, NOMINAL SIZE NOTED	WOOD	REMOVE EXISTING WINDOWS AND PLACE ENERGY CODE COMPLIANT WOOD OR VINYL REPLACEMENTS TO SIZE

(a) HARDWARE TO BE COMMERCIAL GRADE AS MANUFACTURED BY RUSSWIN, SCHLAGE, VON DUPRE, LNC CLOSERS, IVES, PLYCO, OR EQUAL, ADA APPROVED.  
 (b) PLACE NEW, ADDITIONAL DOUBLE 2"x8" HEADER AS PER TYPICAL SECTION AT ALL EXISTING WINDOW OPENINGS.

ROOM FINISH SCHEDULE(a)

NO.	ROOM NAME	FLOORING(c)	WALL(b)	CEILING(b)	NOTES
101	WAITING AREA	LAMINATE	EXPOSED BRICK VENEER & DRYWALL	7'10"± DRYWALL	
102	CLIENT SERVICE	LAMINATE	DRYWALL w/WOOD BASE	9'0"± DRYWALL	
103	CLIENT SERVICE OFFICE & RESTROOM	LAMINATE	DRYWALL w/WOOD BASE	9'0"± DRYWALL	
104	STAIRWAY	LAMINATE	DRYWALL w/WOOD BASE	VARIES DRYWALL	
105	RESTROOM	LAMINATE	DRYWALL w/6" VINYL BASE	8'6"± DRYWALL	(d)
106	DISPENSARY OFFICE/RESTROOM	LAMINATE	DRYWALL w/4" VINYL BASE	8'6"± DRYWALL	
201	MECHANICAL OFFICE	LAMINATE	DRYWALL w/4" VINYL BASE	8'± DRYWALL	
202	WEDDING/MAKE UP OFFICE	LAMINATE	DRYWALL w/WOOD BASE	8'± DRYWALL	
203	MASSAGE/FACIAL OFFICE	LAMINATE	DRYWALL w/WOOD BASE	8'± DRYWALL	
204	MASSAGE/FACIAL OFFICE	LAMINATE	DRYWALL w/WOOD BASE	8'± DRYWALL	
205	LOUNGE OFFICE	LAMINATE	DRYWALL w/WOOD BASE	8'± DRYWALL	
206	OFFICE	LAMINATE	DRYWALL w/WOOD BASE	8'± DRYWALL	
207	RESTROOM	LAMINATE	DRYWALL w/6" VINYL BASE	8'± DRYWALL	(d)

(a) ALL MATERIAL FINISH COLORS, STYLES, ETC., SHALL BE CHOSEN BY THE OWNER FROM MANUFACTURER'S STANDARDS.  
 (b) DRYWALL SHALL BE MIN. 1/2" ON WALLS AND 5/8" ON CEILINGS, TAPED SANDED SMOOTH & FINISHED w/ONE COAT PRIMER-SEALER AND TWO COATS OF LATEX SEMI-GLOSS ENAMEL PAINT, TEXTURED OR KNOCK-DOWN FINISH OPTIONAL ON ALL WALLS & CEILING PER OWNER'S CHOICE.  
 (c) CARPET SHALL COMPLY WITH THE REQUIREMENTS OF DOC FF-1 "PHIL TEST". REPLACE EXISTING CARPET OR PROVIDE PROOF OF COMPLIANCE FOR EXISTING MATERIAL.  
 (d) RESTROOM WALLS WITHIN 24" OF THE WATER CLOSET, AND TO A HEIGHT OF 48" ABOVE THE FLOOR, SHALL BE FINISHED w/AN EPOXY BASED SEMI-GLOSS PAINT OR COVERED w/WHITE "FRP" PANELS GLUED DIRECTLY TO THE FINISHED DRYWALL.

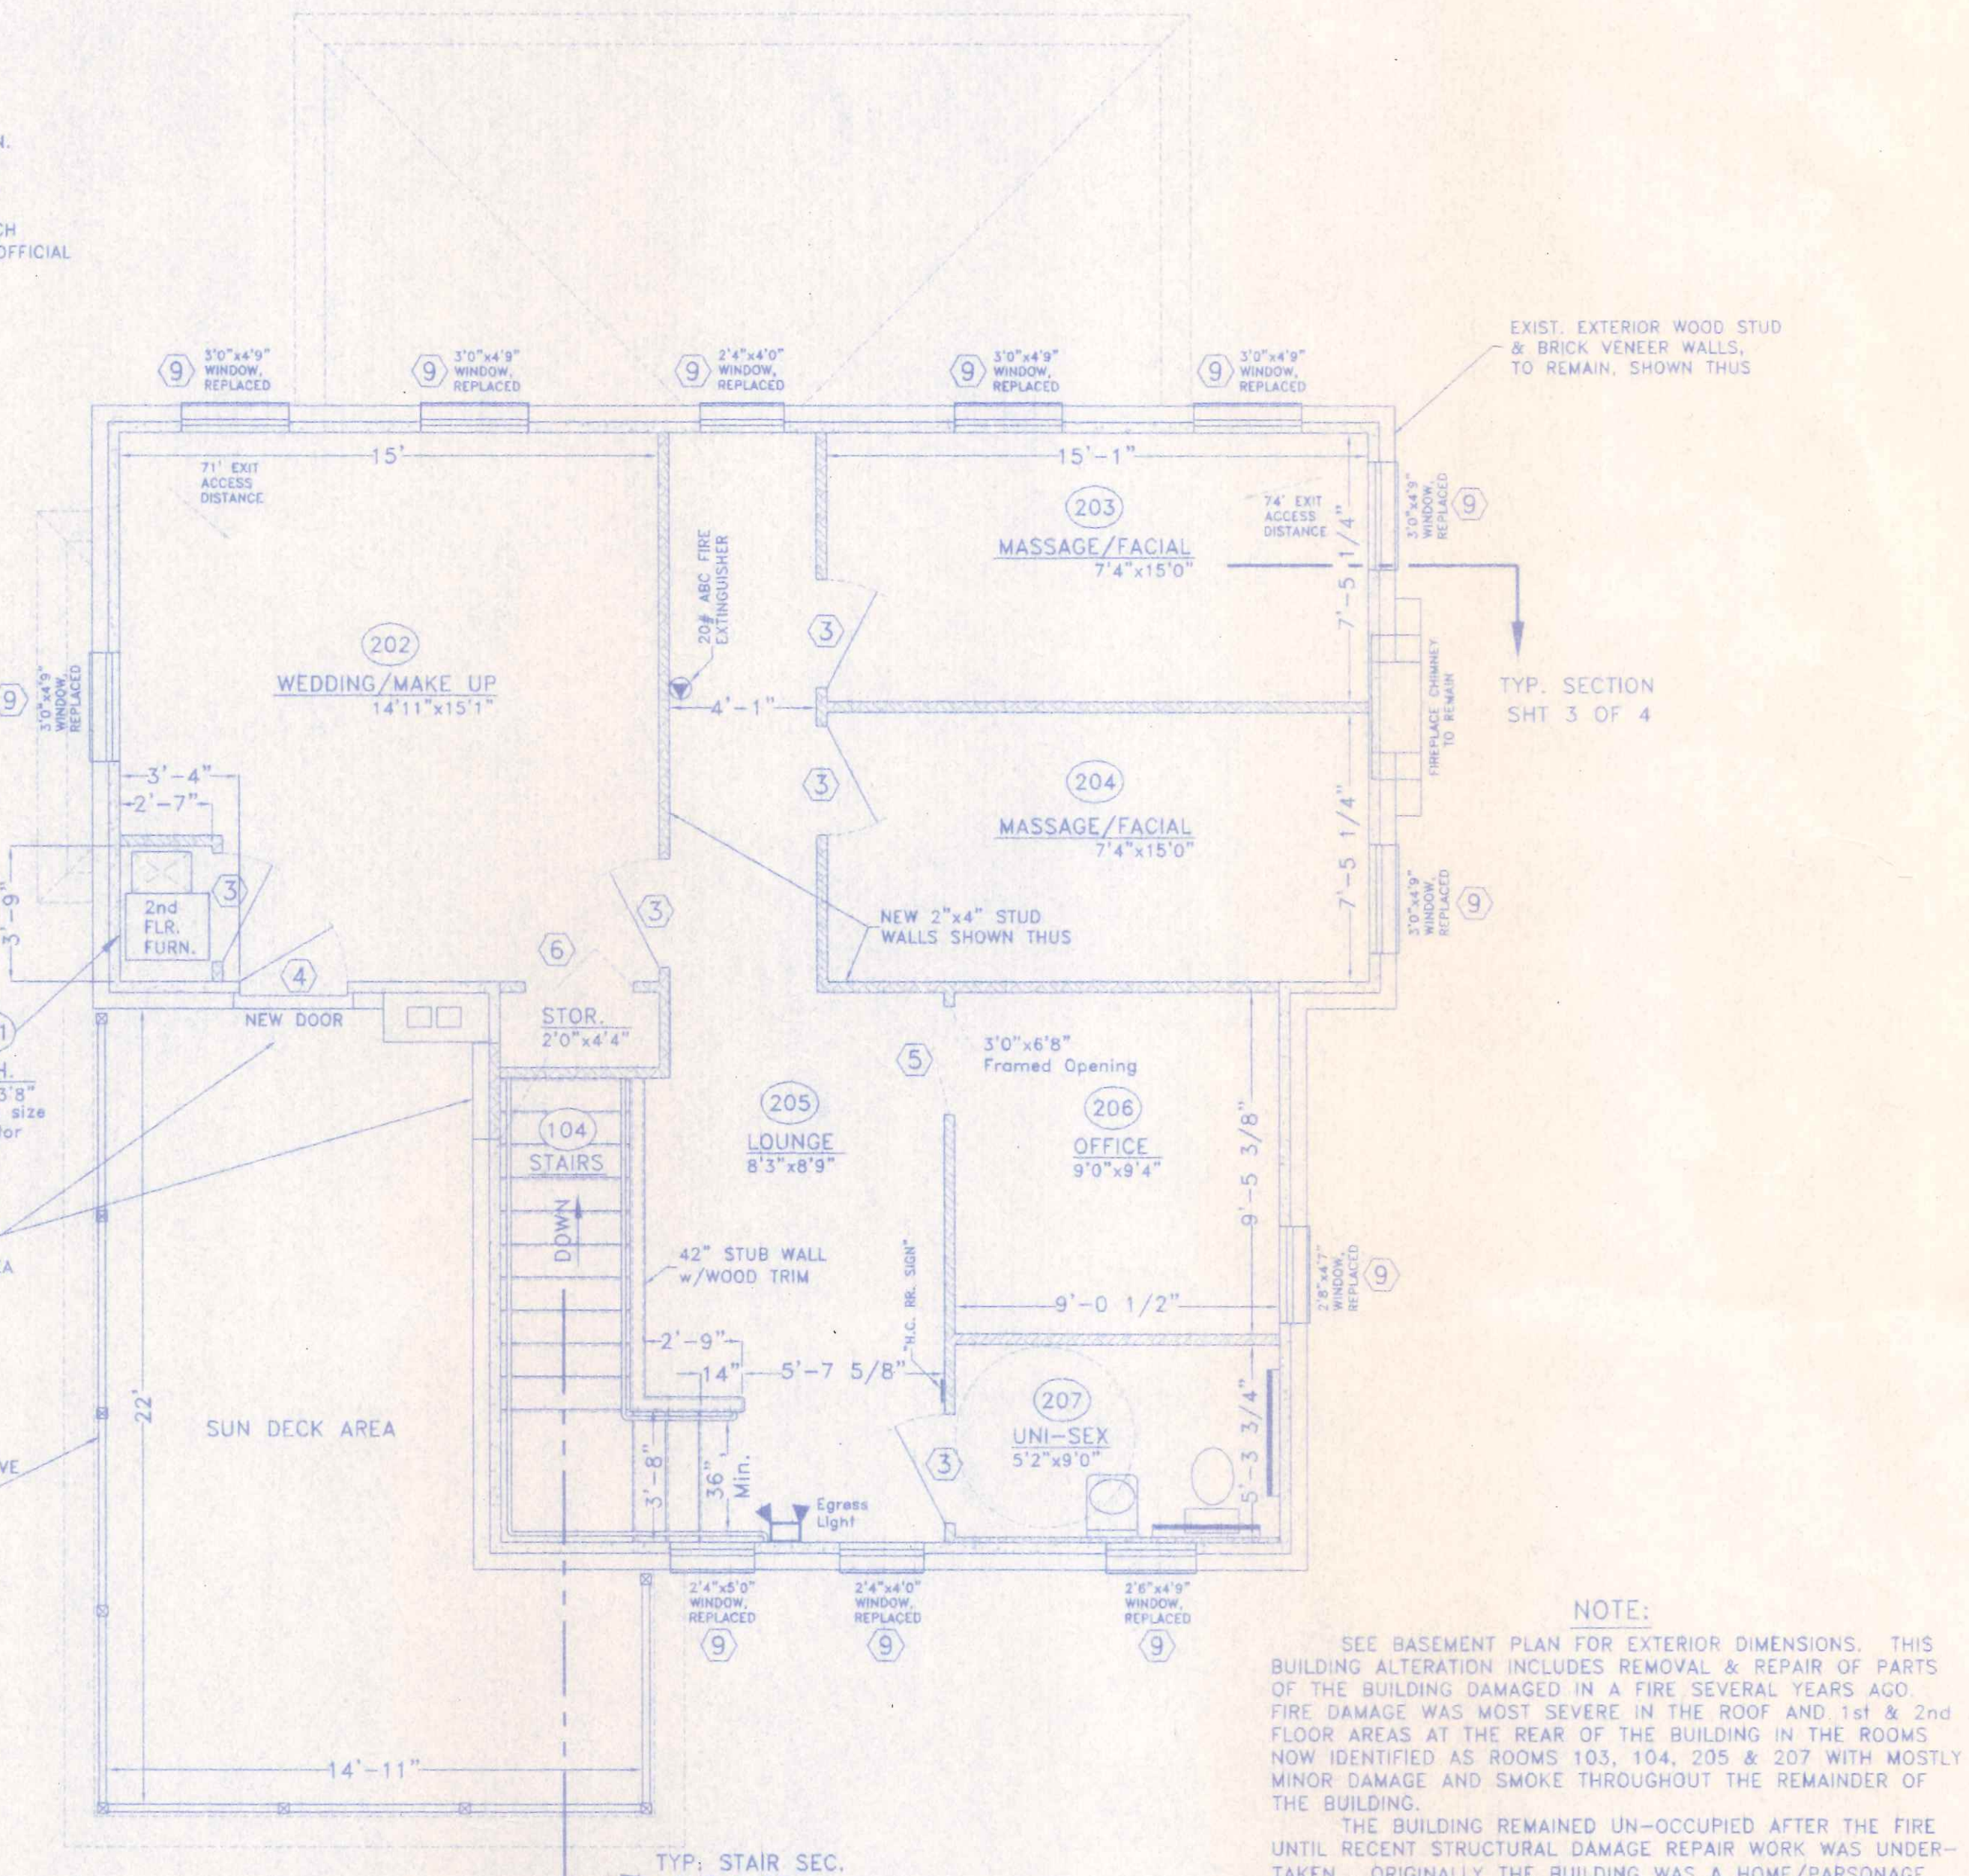

SECOND FLOOR PLAN


MINIMUM INSULATION VALUES:

WALLS: R-13  
 CEILINGS: R-30  
 WINDOWS: U-0.35, SHGC-.40 (where req'd.)  
 MAIN ENTRY DOOR: U-0.80  
 OTHER EXTERIOR DOORS: U-0.55


BUILDING DATA:

USE GROUP: "B" BEAUTY SALON (FORMERLY INSURANCE OFFICE)  
 CONSTRUCTION TYPE: V-B, UNPROTECTED  
 AREA: ALLOWABLE: 9,000 SQ. FT. (Table 503)  
 EXISTING BASEMENT: 1,168 SQ. FT. TOTAL AREA (NO CHANGE)  
 EXISTING 1st FLOOR: 1,476 SQ. FT. TOTAL AREA (NO CHANGE)  
 EXISTING 2nd FLOOR: 967 SQ. FT. TOTAL AREA (NO CHANGE)  
 TOTAL EXISTING: 3,611 SQ. FT. TOTAL AREA (NO CHANGE)  
 HEIGHT: ALLOWABLE: 40' - 2 STORY (Table 503)  
 PROPOSED: 25'± - 2 STORY (NO CHANGE)  
 MAXIMUM OCCUPANCY LOAD: 1st FLOOR 14 PERSONS (Per Table 1004.1.1)  
 2nd FLOOR 9 PERSONS (Per Table 1004.1.1)  
 TOTAL OCCUPANCY LOAD: 23 PERSONS (Occupancy Load for Life Safety Purposes per Table 1004.1.1)  
 ACTUAL OCCUPANCY LOAD: 13 PERSONS (Est. normal occupancy load)  
 MAXIMUM EXIT ACCESS TRAVEL DISTANCE: 200' ALLOWABLE  
 MAX. COMMON PATH TRAVEL DISTANCE: 100' ALLOWABLE (1014.3 Exc.2)  
 MAX. 1st FLOOR DISTANCE: 60' PROPOSED  
 MAX. 2nd FLOOR DISTANCE: 74' PROPOSED  
 DESIGN LOADS: FLOOR - 50 psf. LIVE plus DEAD LOAD  
 ROOF - EXISTING TO REMAIN - NO CHANGE  
 WIND - EXPOSURE "B", 76 mph basic wind speed,

NOTE:  
 SEE BASEMENT PLAN FOR EXTERIOR DIMENSIONS. THIS BUILDING ALTERATION INCLUDES REMOVAL & REPAIR OF PARTS OF THE BUILDING DAMAGED IN A FIRE SEVERAL YEARS AGO. FIRE DAMAGE WAS MOST SEVERE IN THE ROOF AND 1st & 2nd FLOOR AREAS AT THE REAR OF THE BUILDING IN THE ROOMS NOW IDENTIFIED AS ROOMS 103, 104, 205 & 207 WITH MOSTLY MINOR DAMAGE AND SMOKE THROUGHOUT THE REMAINDER OF THE BUILDING.  
 THE BUILDING REMAINED UN-OCCUPIED AFTER THE FIRE UNTIL RECENT STRUCTURAL DAMAGE REPAIR WORK WAS UNDERTAKEN. ORIGINALLY THE BUILDING WAS A HOME/PARSONAGE FOR A LOCAL CONGREGATION. IT WAS THEN USED AS AN INSURANCE AGENCY OFFICE FOR PERHAPS 20-25 YEARS, FOLLOWING THAT IT WAS ONCE AGAIN BRIEFLY USED AS A DWELLING UNTIL THE FIRE OCCURRED; AND THEN REMAINED UN-USED WHILE ISSUES SURROUNDING THE FIRE WERE RESOLVED. AS A PART OF THE FIRE DAMAGE REPAIR AND CLEAN-UP, AND ALSO DUE TO THE STRUCTURE'S AGE, THE REPAIR-CLEAN UP INCLUDED REMOVING THE OLD WINDOWS, WALLS INSULATION & FINISH MATERIAL AS WELL AS OLD ELECTRICAL WIRING, PLUMBING AND MECHANICAL SYSTEMS. DURING THE REPAIR-CLEAN OPERATIONS THE STRUCTURE WAS RE-ROOFED TO PREVENT WEATHER DAMAGE AND THESE PLANS WERE PREPARED TO DETAIL THE BUILDING'S PROPOSED CURRENT USE AS A SALON/SPA.


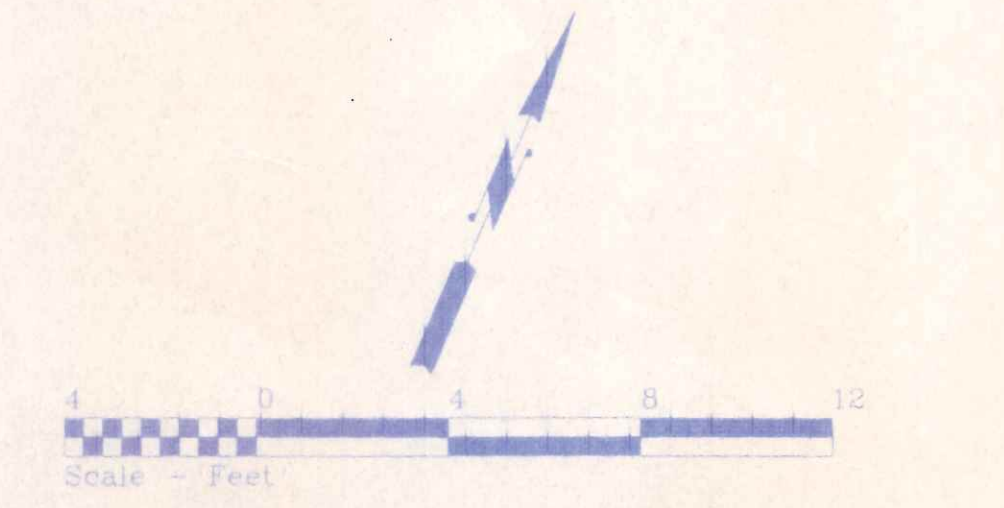


**TOPPER'S SALON & SPA**  
 221 W. CLINTON STREET 419.438.7984 NAPOLEON, OHIO  
 DIRECTORY: C:\NO\_CUSTOM\DAMIAN SALON FILE NAME: FLRELEV REVISD:  
 DRAWN BY: R.D.S. ~ dpo: NEW DIMENSIONS  
 BUILDING ALTERATIONS SCALE: 1/4"=1'-0"  
 FLOOR PLANS & FINISH SCHEDULES DATE: JULY 2010  
 DRAWING NUMBER: 2 of 4



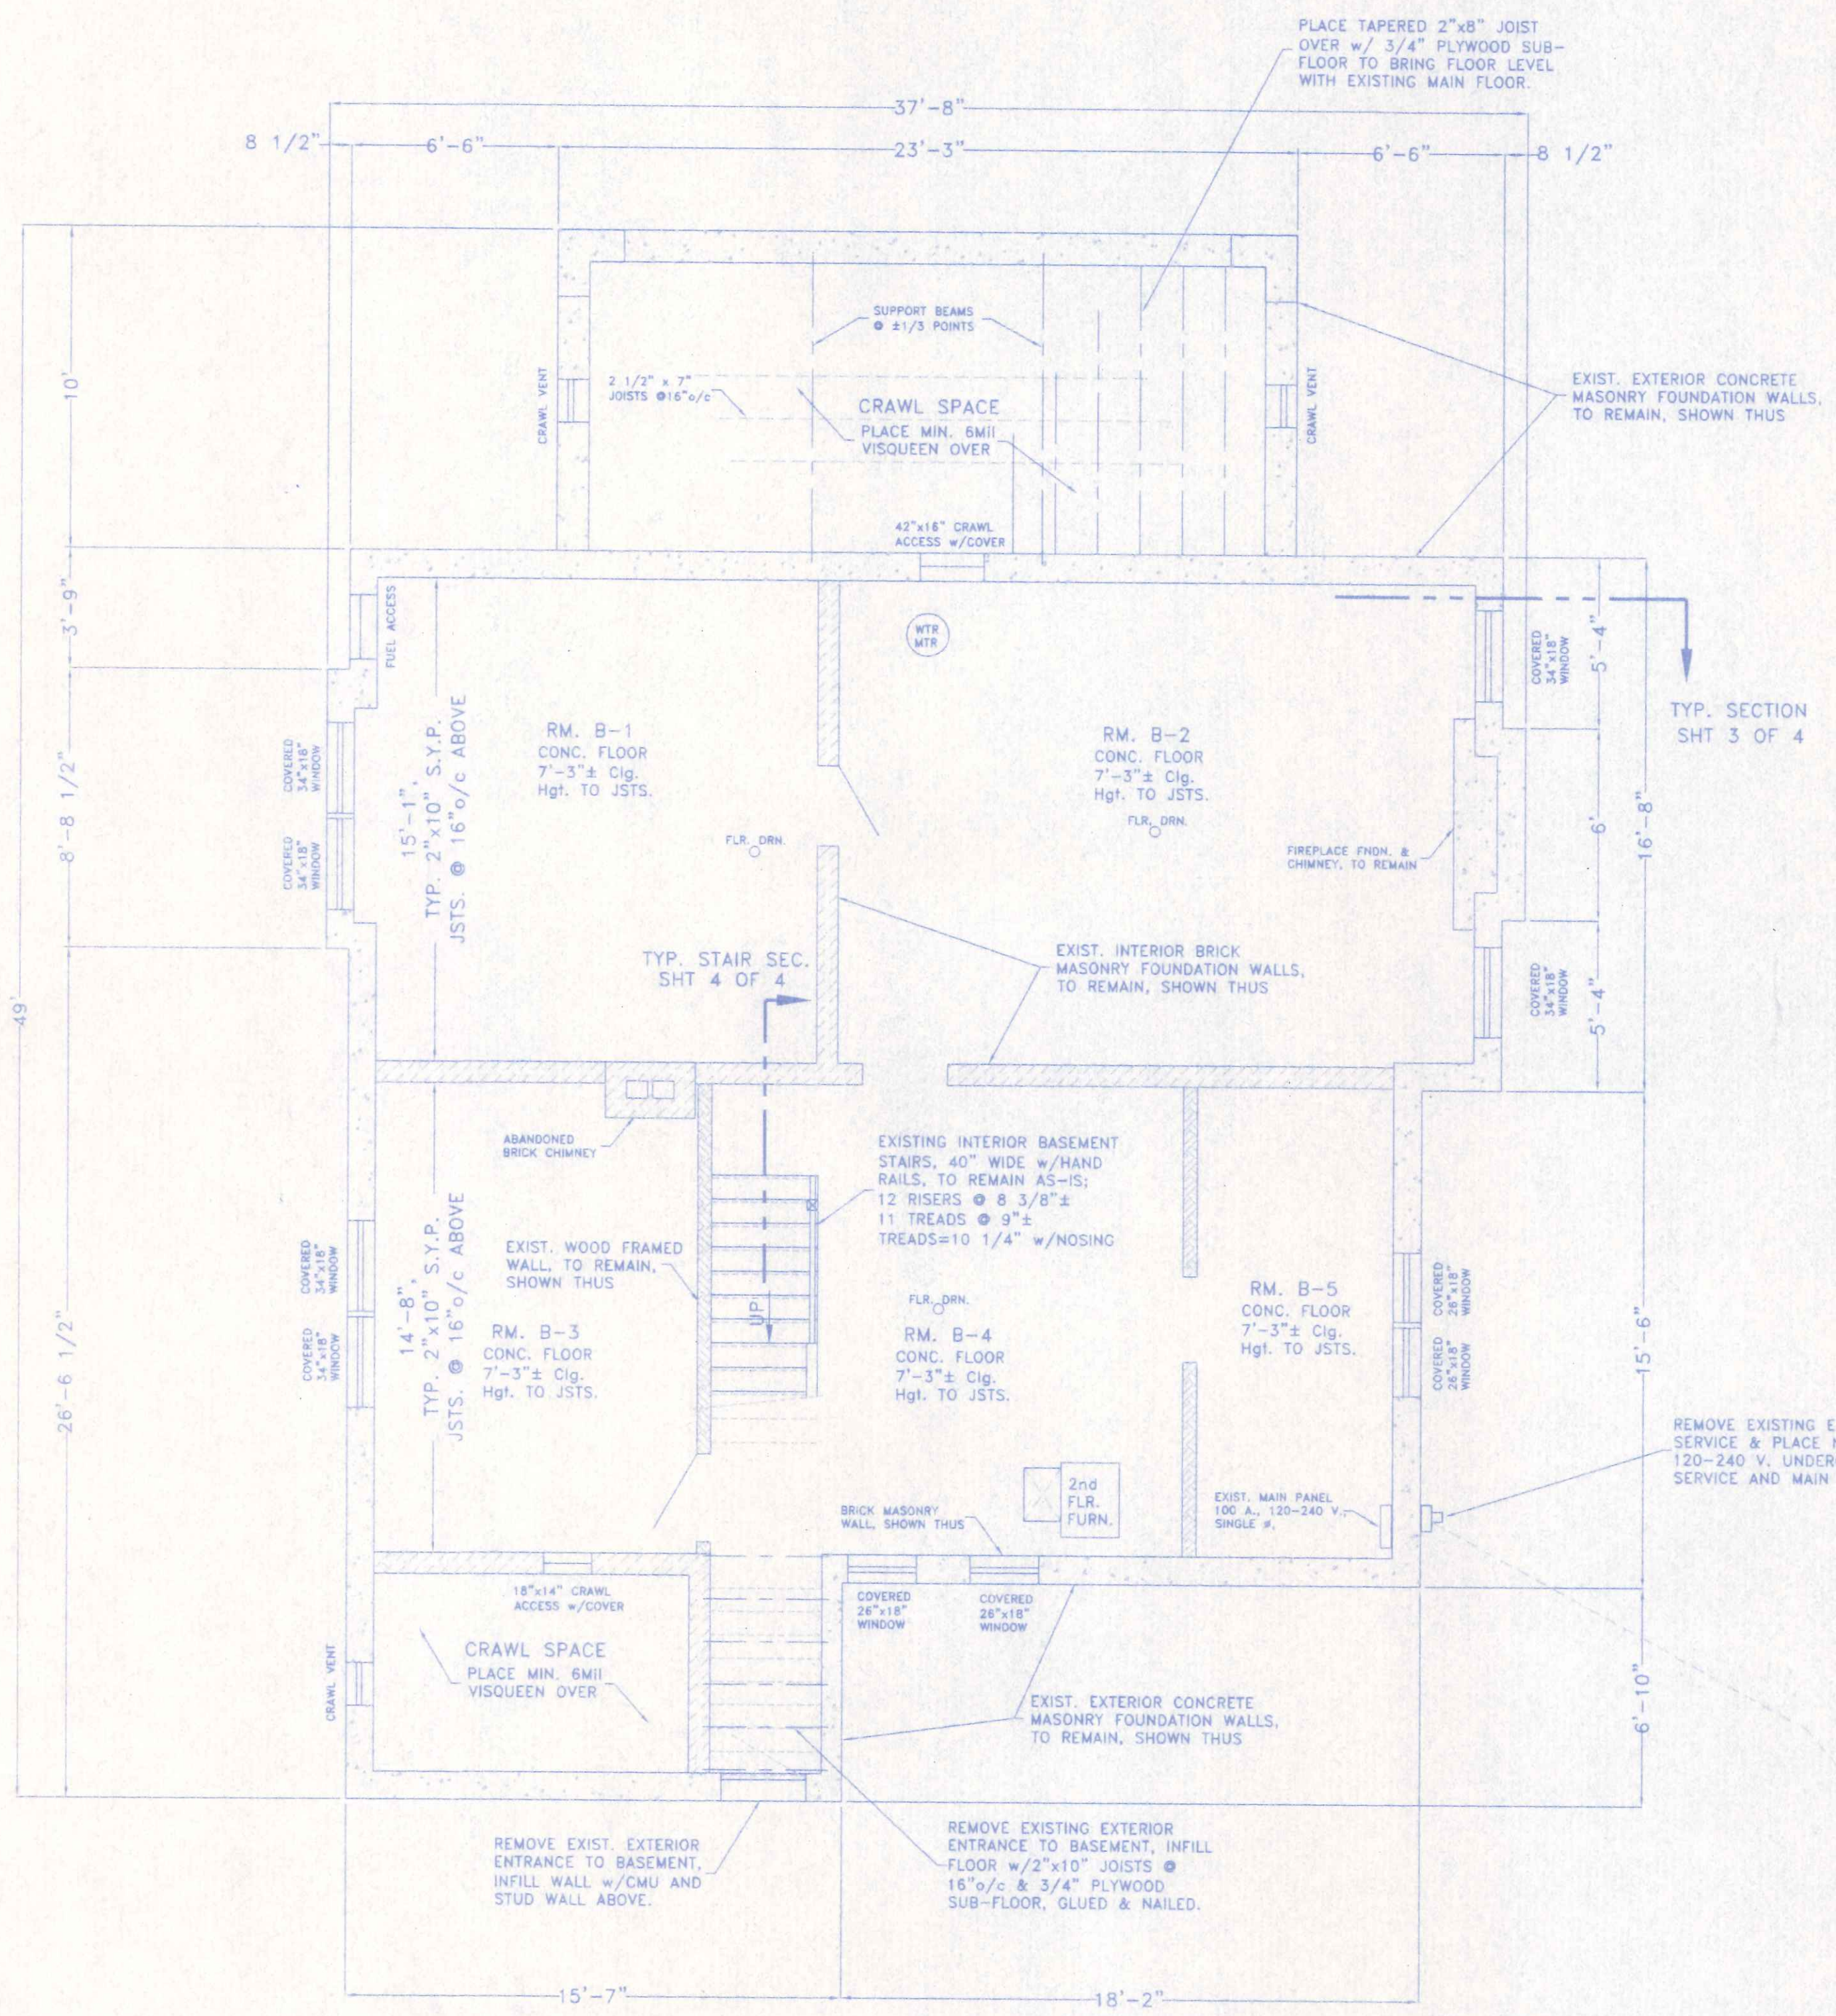


**BASEMENT PLAN**




NOTE: THE BASEMENT AREA RECEIVED NO SUBSTANTIAL FIRE DAMAGE. THIS AREA IS TO BE UTILIZED ONLY FOR BUILDING SERVICE EQUIPMENT. NO PUBLIC ACCESS

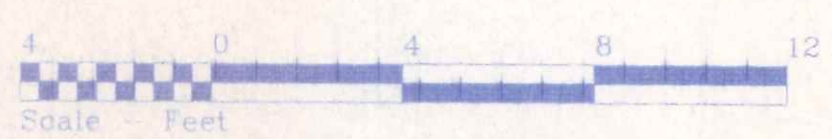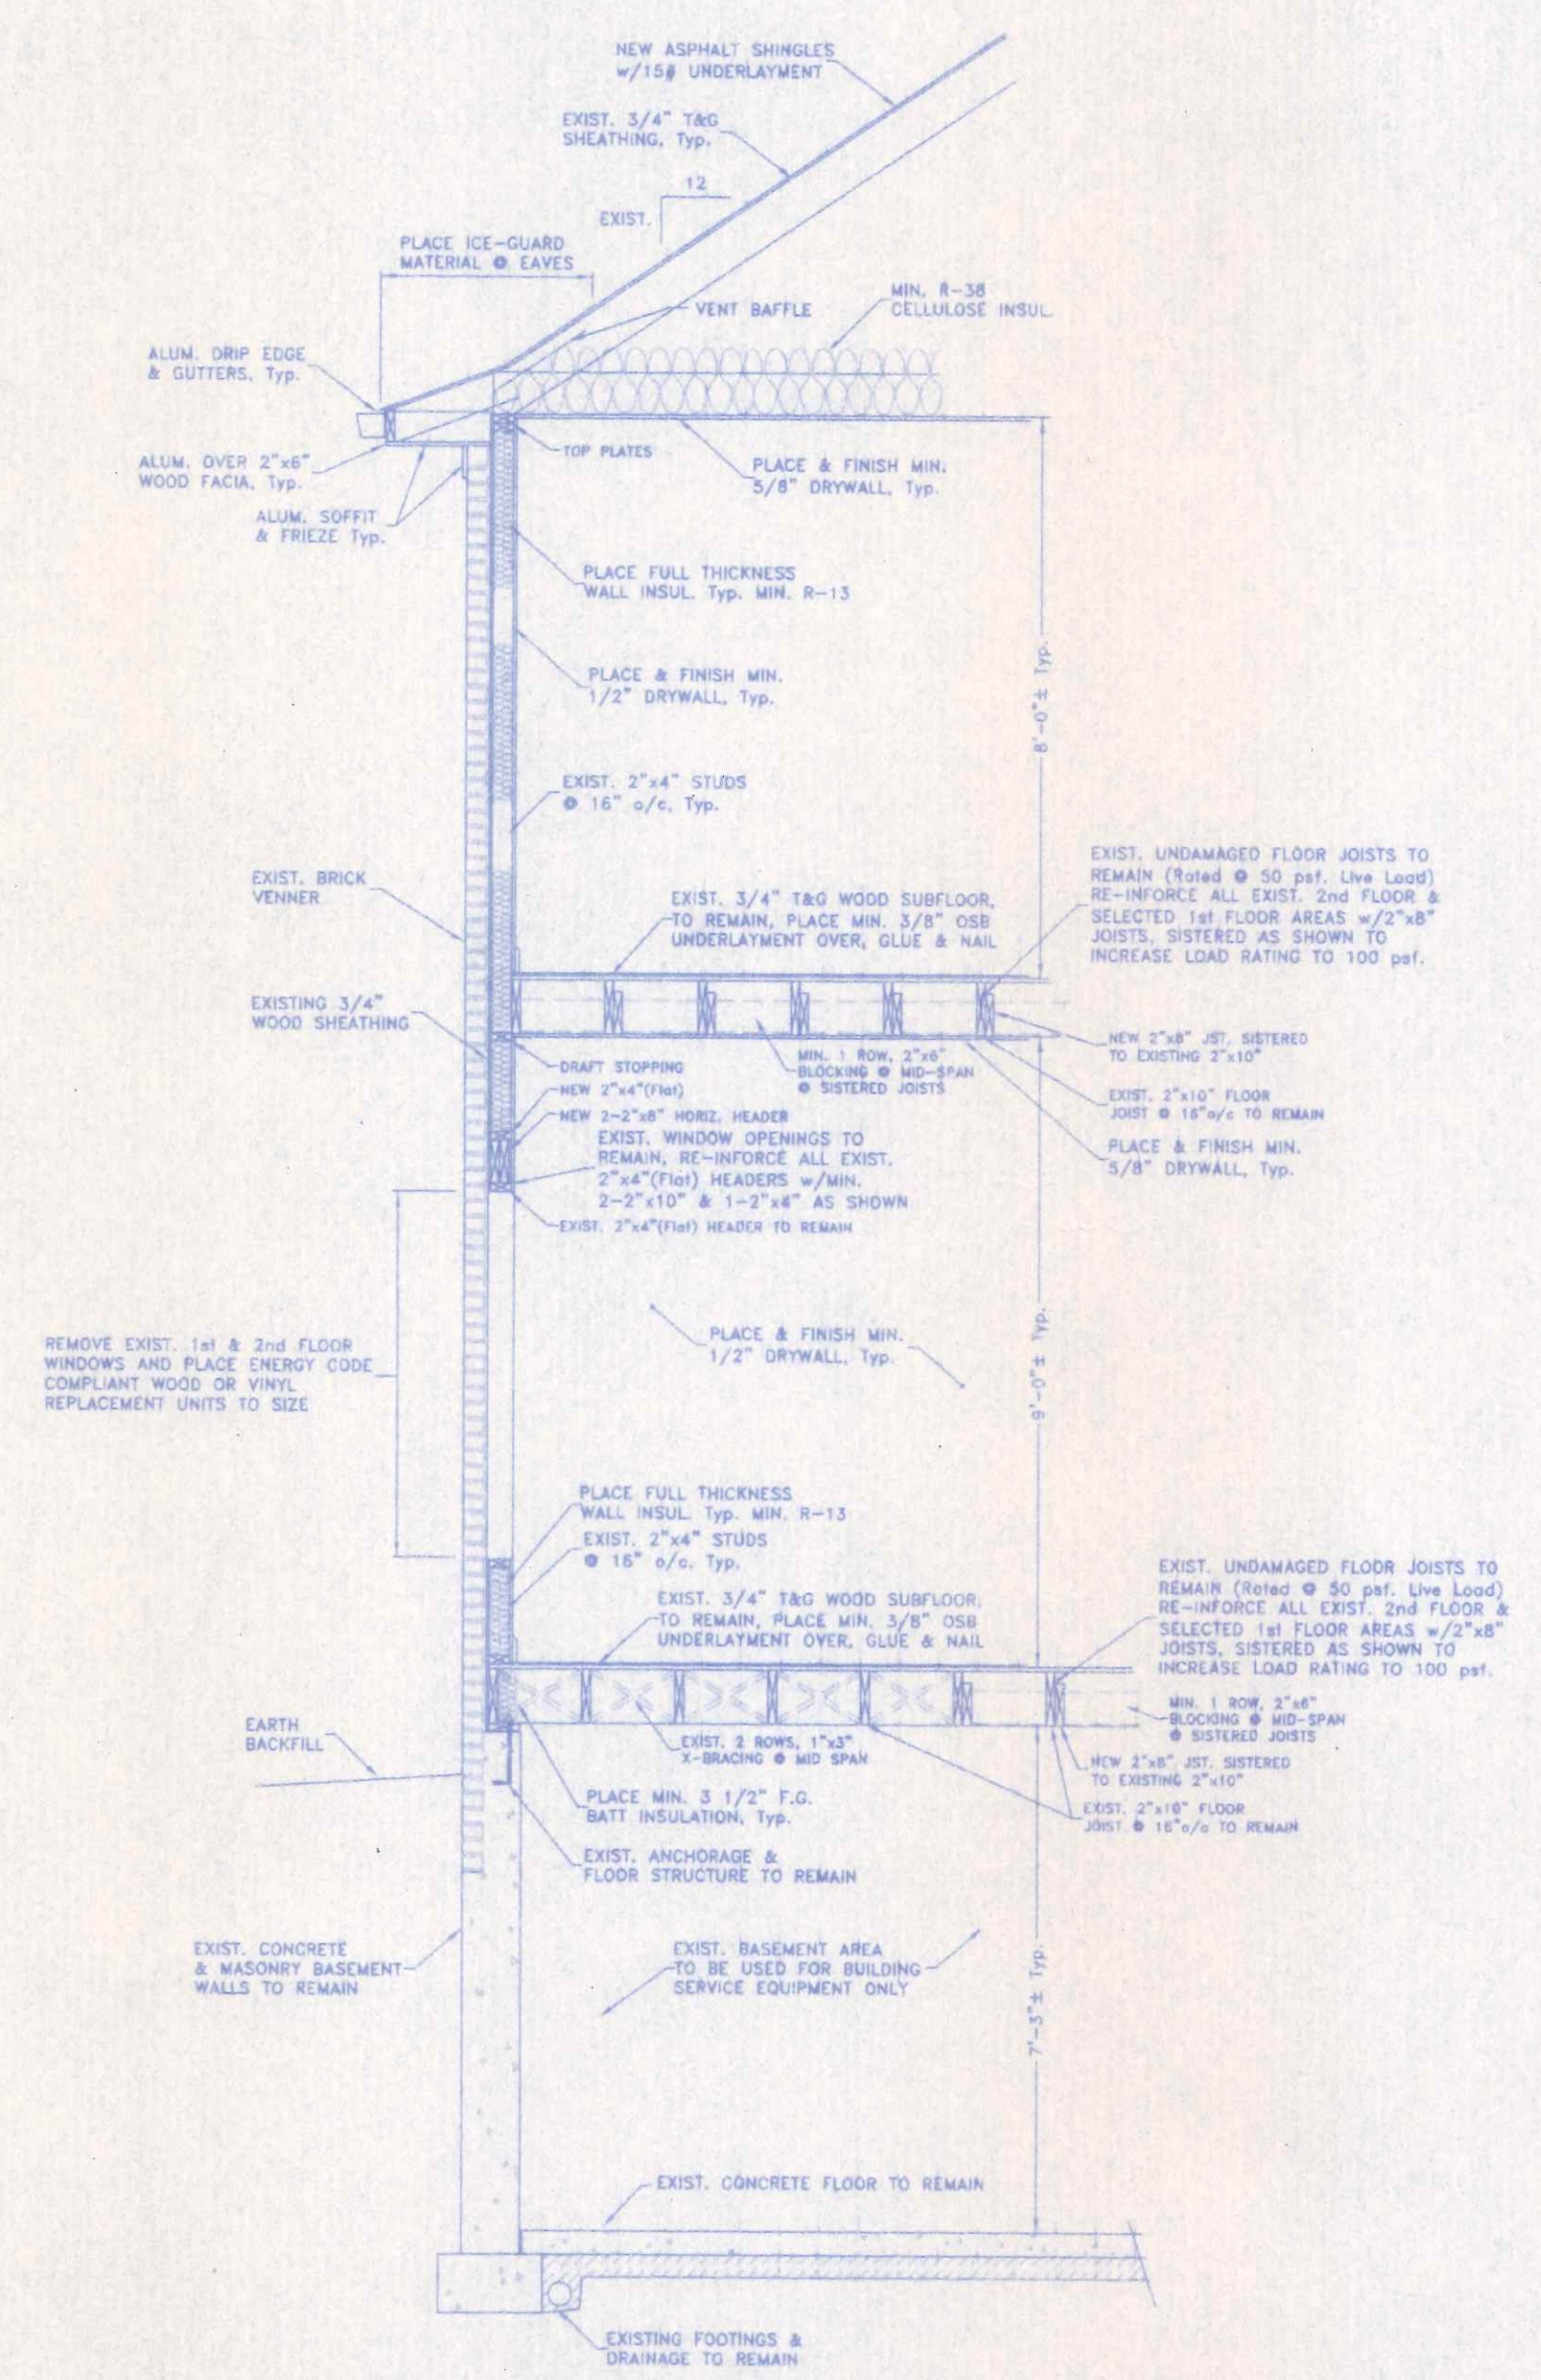

<b>TOPPER'S SALON &amp; SPA</b>			
221 W. CLINTON STREET		419.438.7984	
NAPOLIEN, OHIO			
DIRECTORY: C:\IND\CUSTOM\DAAMAN	FILE NAME: FLEVEY	REVISED:	
DRAWN BY: R.D.S. ~ dbr: NEW DIMENSIONS		SCALE: 1/4"=1'-0"	
BUILDING ALTERATIONS; GEN. SPEC'S.		DATE: JULY 2010	
BASEMENT PLAN & TYPICAL SECTION		DRAWING NUMBER:	3 of 4

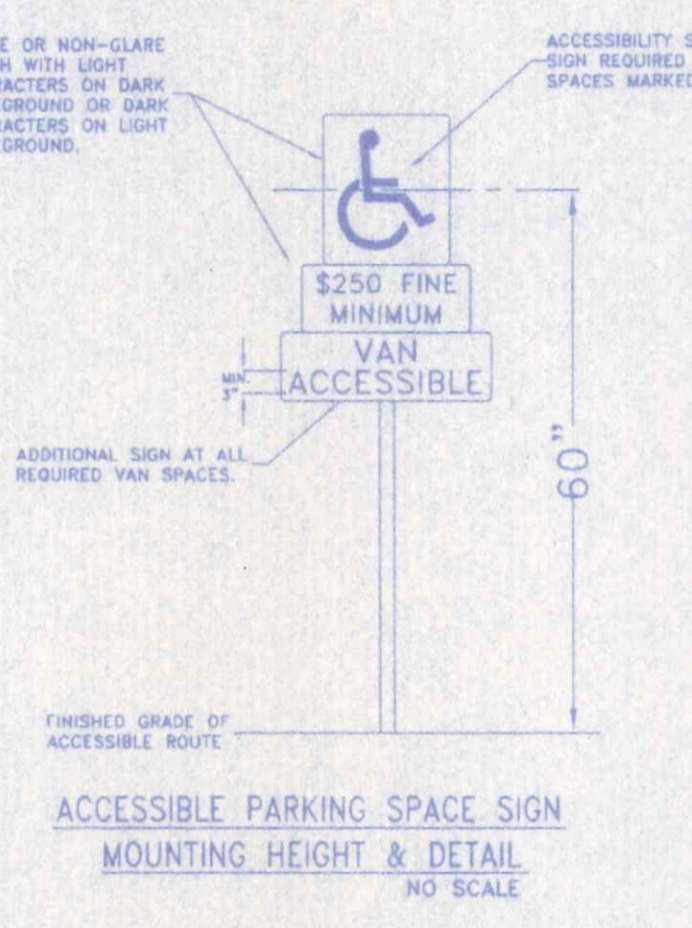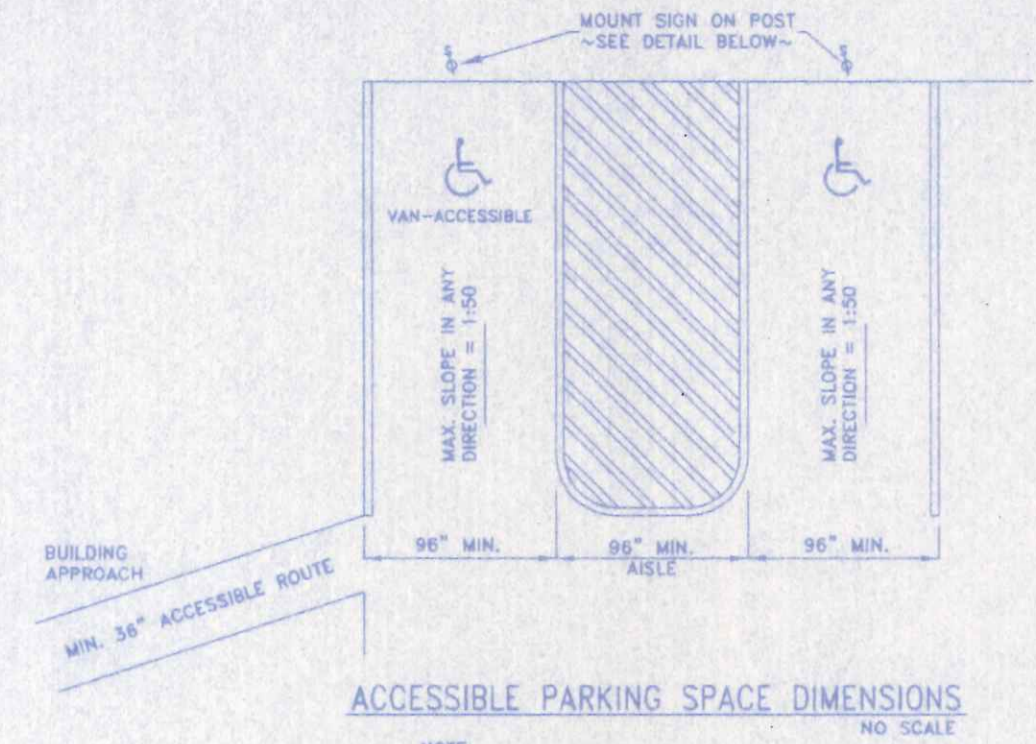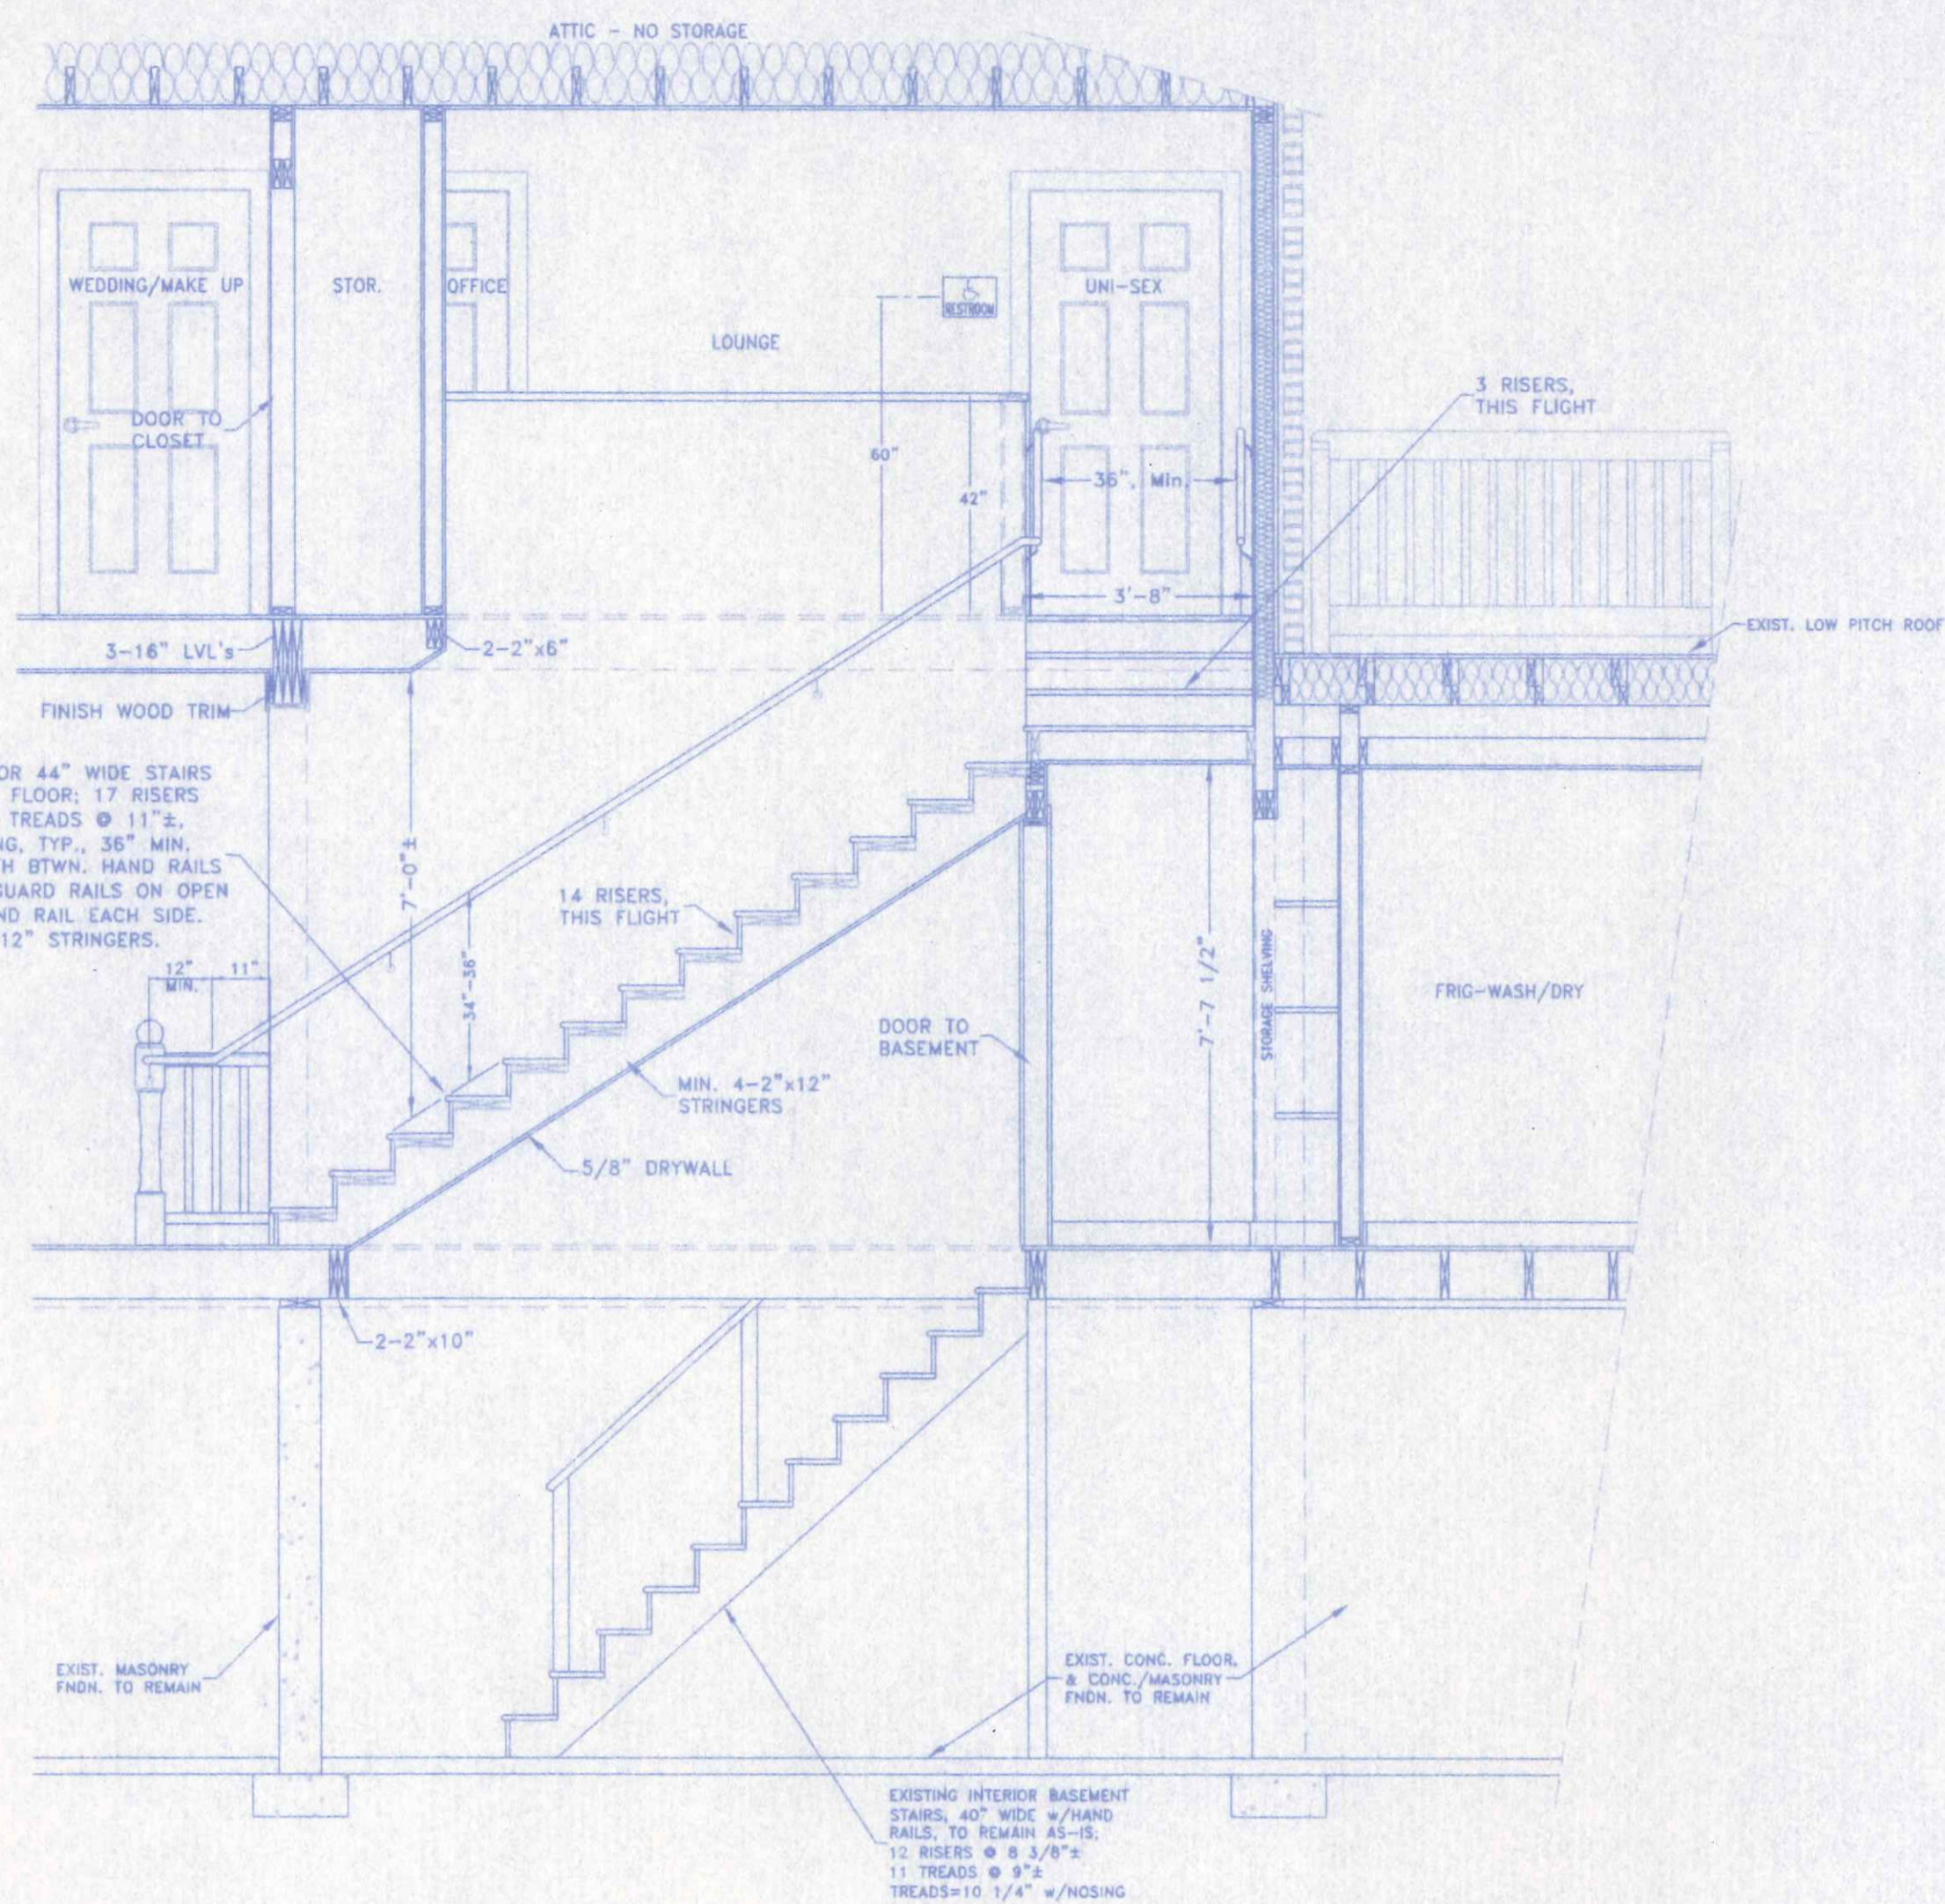

ADDAG. FIXTURE & PARKING DETAILS

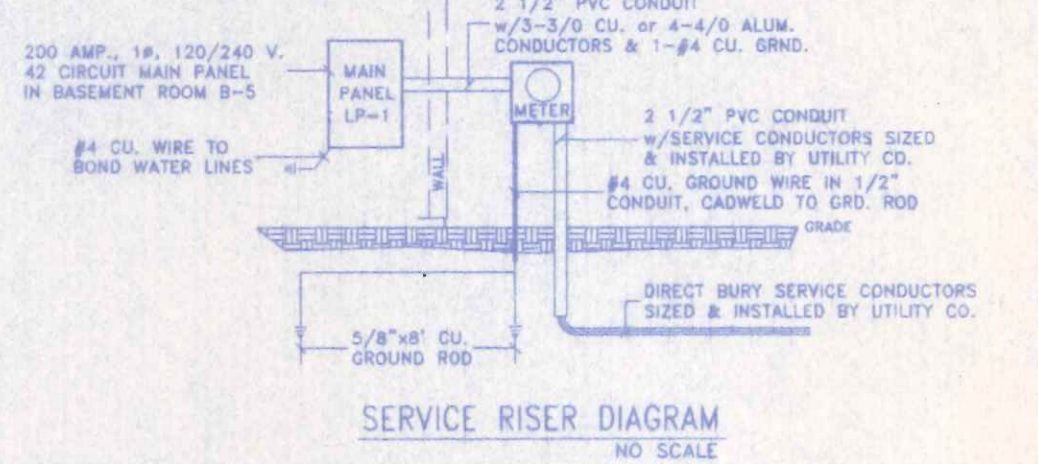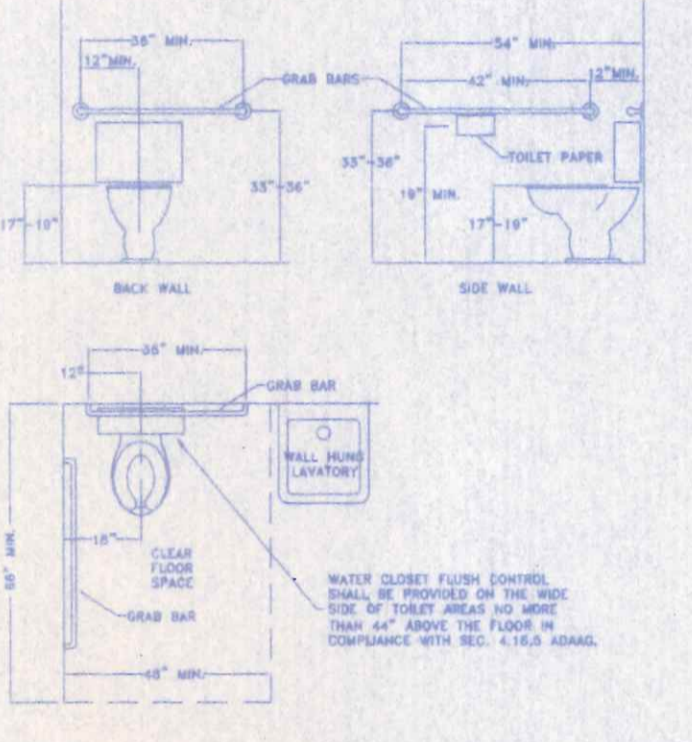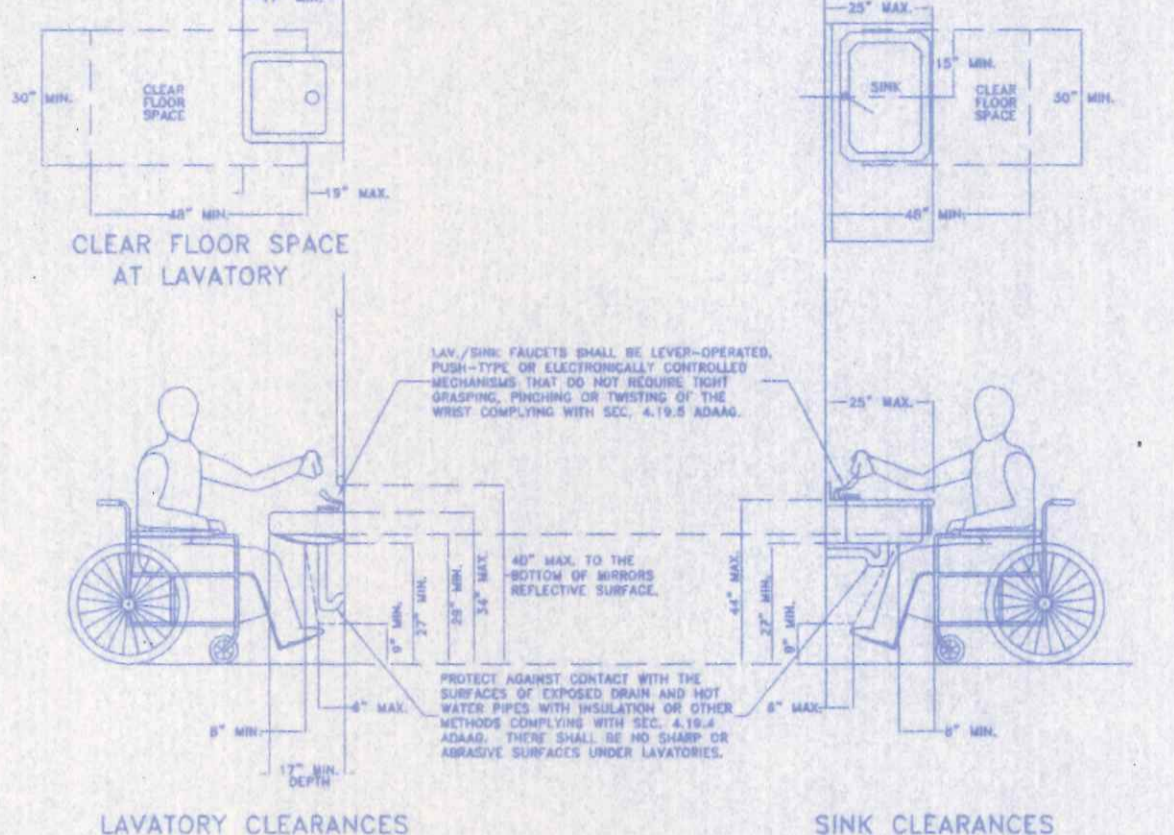

**ELECTRICAL NOTES**

- CONTRACTOR SHALL VISIT THE SITE AS TO SATISFY HIMSELF AS TO THE CONDITIONS UNDER WHICH THE WORK IS TO BE PERFORMED.
- ALL ELECTRICAL WORK SHALL BE INSPECTED AND APPROVED BY THE STATE BUILDING INSPECTION AGENCY, OR THE LOCAL INSPECTION AGENCY HAVING JURISDICTION. A FINAL CERTIFICATE OF INSPECTION AND APPROVAL FORWARDED TO THE OWNER AND ENGINEER AT THE COMPLETION OF THE PROJECT.
- ALL ELECTRICAL WORK SHALL CONFORM TO THE LATEST EDITION OF THE NATIONAL ELECTRIC CODE AND ALL APPLICABLE STATE AND LOCAL CODES AND ORDINANCES.
- ALL RACEWAYS BURIED IN EARTH, RUN EXPOSED, CAST IN CONCRETE OR INSTALLED IN EXTERIOR WALLS SHALL BE RIGID, GALVANIZED STEEL CONDUIT. CONDUITS BURIED IN EARTH OR CAST IN CONCRETE MAY BE PVC SCH. 40 CONDUIT WITH BRASS STEEL EDGERS AND REEBS, 3/4" DIAMETER MINIMUM. A GROUND WIRE SHALL BE ADDED IN ALL PVC CONDUIT RUNS. TYPE "NM" WIRE IN CONCEALED LOCATIONS ALLOWED AS PER CODE.
- ALL CONDUCTORS NO. 2 AND LARGER SHALL BE STRANDED COPPER CONDUCTORS WITH 90 VOLT, 70°C TYP. MIN. OF THIN INSULATION.
- BRANCH CIRCUIT WIRING SHALL BE COPPER CONDUCTORS, MIN. #12 "NM" CABLE OR #12 AWG. RIGID, 70°C WIRE, TYPE THIN OR THIN INSULATION.
- CONTRACTOR SHALL GUARANTEE HIS WORKMANSHIP AND ALL MATERIALS (EXCEPT LAMPS) FOR A PERIOD OF ONE (1) YEAR FROM DATE OF FINAL ACCEPTANCE.
- ALL MATERIALS FURNISHED AND/OR INSTALLED UNDER THIS CONTRACT SHALL BE NEW UNLESS SPECIFICALLY NOTED OTHERWISE AND SHALL BE U.L. LISTED, LIGHT FIXTURES SHALL BE AS MANUFACTURED BY DAY-BRITE LIGHTING DIVISION, EMERSON ELECTRIC CO., METALUX, ULTRALUX OR ALTERNATES AS APPROVED BY THE ENGINEER.
- THIS CONTRACTOR SHALL REMOVE DEBRIS CREATED BY THIS PORTION OF THE CONTRACT AND SHALL CLEAN ALL FIXTURES, PANELS, EQUIPMENT, ETC. AT THE COMPLETION OF THE PROJECT.
- BRANCH CIRCUIT CONDUCTORS SHALL HAVE AN AMPACITY RATING NOT LESS THAN THE MAXIMUM LOAD TO BE SERVED. CONDUCTORS OF MULTI-OUTLET BRANCH CIRCUITS SUPPLYING RECEPTACLES SHALL HAVE AMPACITY RATING NOT LESS THAN THE RATING OF THE BRANCH CIRCUIT BREAKER.
- ALL ELECTRICAL OUTLETS, LIGHT SWITCHES, OPERABLE PARTS OF CONTROLS, DISPENSERS, RECEPTACLES AND OTHER OPERABLE EQUIPMENT SHALL BE PLACED WITHIN THE LIMITS SPECIFIED IN ADAAG 4.27.3. SWITCH & CONTROL HEIGHTS: MAX. 48" FOR FRONT REACH, RECEPTACLE HEIGHT: MIN. 15" ABOVE FLOOR.
- CONTROLS AND OPERATING MECHANISMS SHALL BE OPERABLE WITH ONE HAND AND SHALL NOT REQUIRE FIGHT GRASPING, PINCHING, OR TWISTING OF THE WRIST. THE FORCE REQUIRED TO ACTIVATE CONTROLS SHALL BE NO GREATER THAN 5 LB.
- MEANS OF EGRESS LIGHTING SHALL BE SERVED BY THE SAME CIRCUIT AS THE NORMAL ROOM LIGHTING, CONNECTED AHEAD OF ANY LOCAL SWITCHES. SEE PLAN SHEET 2 OF 4 FOR PROPOSED LOCATION OF MEANS OF EGRESS LIGHTS SHOWN THIS.
- ALL EMERGENCY AND MEANS OF EGRESS LIGHTING SHALL BE PROVIDED WITH BATTERY BACKUP SYSTEMS CAPABLE OF PROVIDING POWER FOR A DURATION OF 90 MINUTES, MIN. WITH ADEQUATE POWER TO PROVIDE FULL ILLUMINATION OF EXIT SIGNS AND MEANS OF EGRESS LIGHTING OF 1 FOOT-CANDLE MINIMUM, TO REQUIRED EXIT DISCHARGE ELEMENTS.
- ELECTRICIAN SHALL PROVIDE POWER & CONNECTION TO THE FOLLOWING EQUIPMENT INSTALLED BY OTHER CONTRACTORS - H.V.A.C. UNITS & WATER HEATER.



WATER SUPPLY DIAGRAM NO SCALE

**PLUMBING NOTES**

- ALL WORK AND MATERIALS SHALL BE IN ACCORDANCE WITH THE LATEST EDITION OF THE OHIO BUILDING & PLUMBING CODES.
- WATER HEATER SHALL BE PROVIDED WITH DIELECTRIC PROTECTION AND AN APPROVED P & T VALVE.
- ALL CLEANDRITS SHALL BE EXTENDED TO THE TOP OF THE FINISHED GRADE OR FLOOR AND PROPERLY GAPPED SO AS TO ALLOW FOR FUTURE ACCESS AND CLEANING.
- MINIMUM FIXTURE SUPPLY PIPE SIZE SHALL BE AS PER TABLE NO. 604.5 OHIO PLUMBING CODE OR MANUFACTURER'S SPECIFICATIONS THE REQUIREMENTS OF ASTM A 1785-85.
- WATER SUPPLY PIPING SHALL BE TYPE K COPPER BELOW GRADE & TYPE L COPPER ABOVE GRADE AS PER ASTM A 82-84 AND MSF-310-14.
- WATER FOR HAND WASHING SHALL NOT EXCEED 120° BY MEANS OF THERMAL MIXING DEVICE AS PER OBC 4101.2-58-(2)(3).
- SEE BUILDING PLAN SHEET 2 OF 4 FOR HANDICAPPED ACCESSIBILITY REQUIREMENTS AND RESTROOM ACCESSORY SCHEDULE.

**H V A C NOTES**

- FURNISH ALL LABOR, MATERIALS, TOOLS, ETC. TO PROVIDE A COMPLETE AND OPERABLE HEATING, VENTILATING, AND AIR CONDITIONING INSTALLATION AS SHOWN ON THE PLANS.
- CONTRACTOR SHALL VISIT THE SITE TO SATISFY HIMSELF AS TO THE CONDITIONS UNDER WHICH THE WORK IS TO BE PERFORMED.
- ALL H.V.A.C. WORK SHALL BE INSPECTED AND APPROVED BY THE STATE BUILDING INSPECTION AGENCY, OR THE LOCAL INSPECTION AGENCY HAVING JURISDICTION.
- ALL WORK SHALL CONFORM TO THE LATEST EDITION OF THE OHIO MECHANICAL CODE AND ALL APPLICABLE STATE AND LOCAL CODES AND ORDINANCES AND SHALL BE INSTALLED IN ACCORDANCE WITH THE CONDITIONS OF ITS LISTING, THE MANUFACTURER'S INSTRUCTIONS.
- EXISTING GAS-BEARING EQUIPMENT SHALL BE REMOVED FROM THE ALTERATION AREA, REMOVE ANY EXISTING SUPPLY & RETURN AIR RUNS IN THE AREA & PROVIDE NEW SUPPLY & RETURN AIR OUTLETS AS REQUIRED.
- THE CONSTRUCTION AND INSTALLATION OF HEATING, VENTILATING AND/OR AIR CONDITIONING DUCTWORK SHALL BE IN ACCORDANCE WITH THE PROVISIONS OF SECTION 403.0 C.M.C.

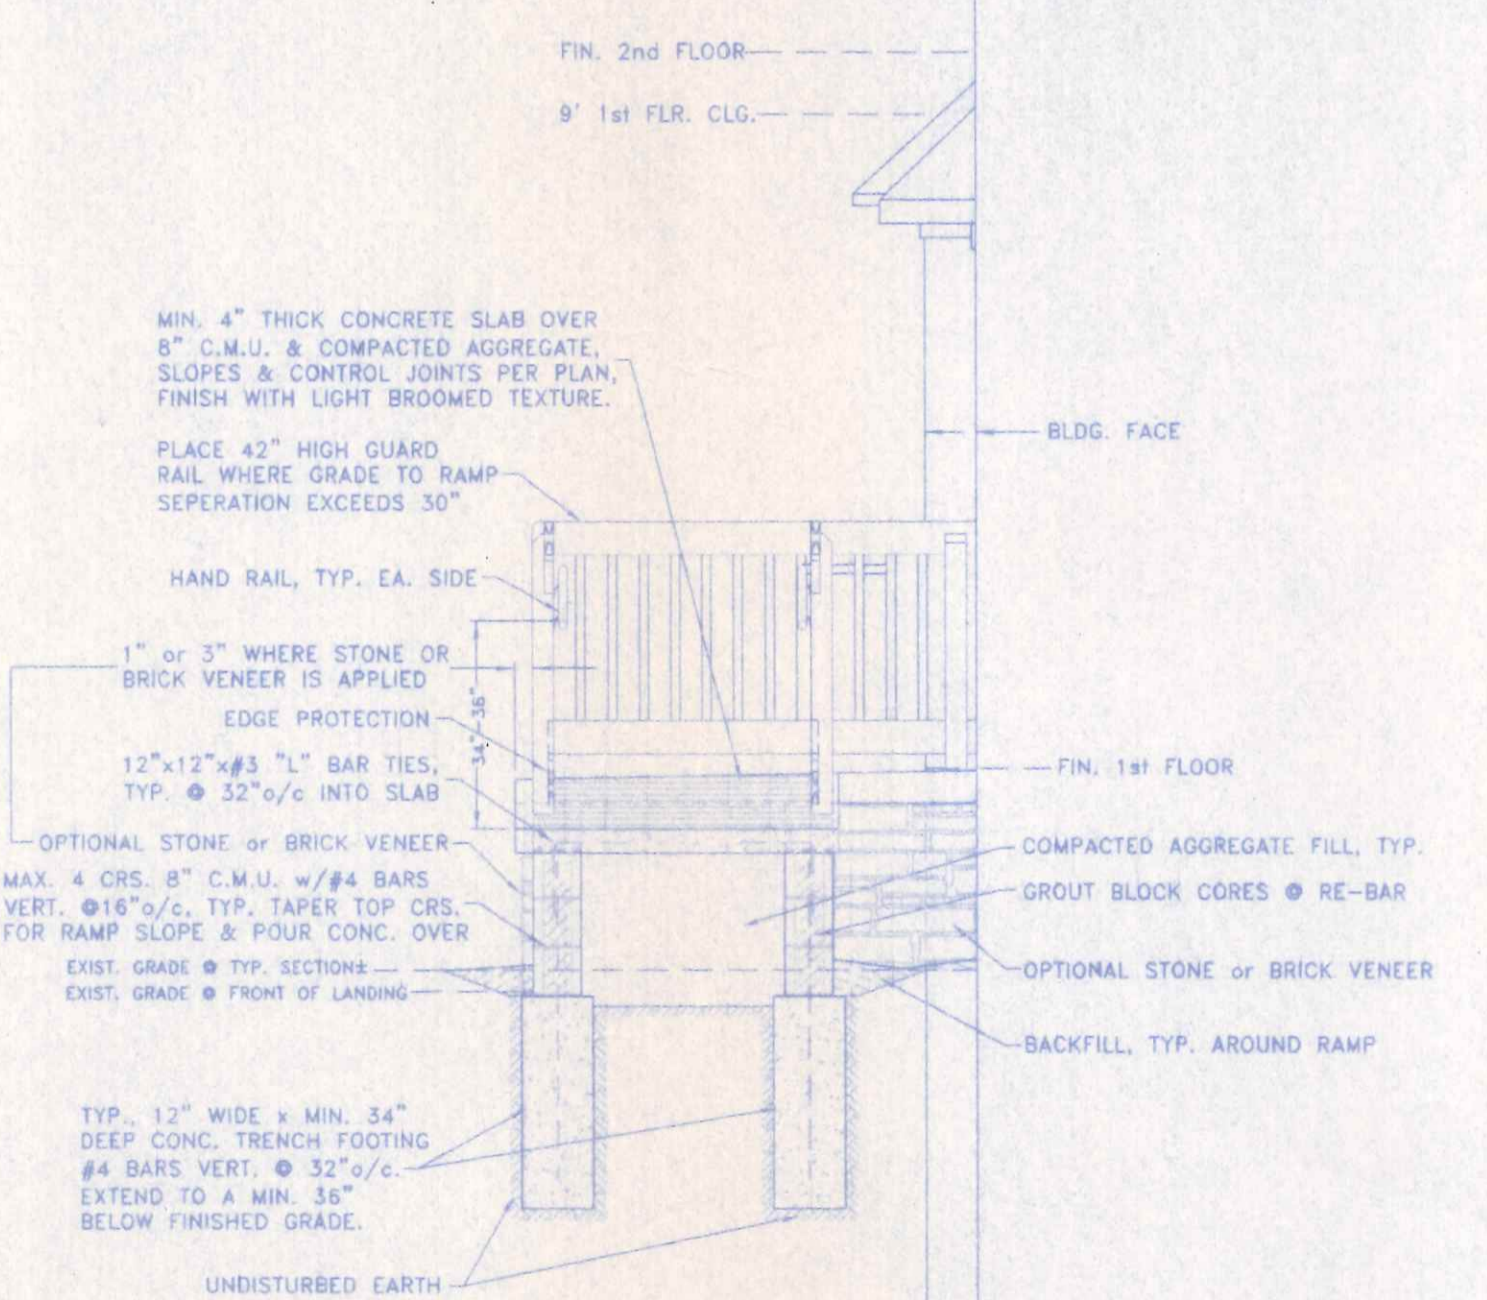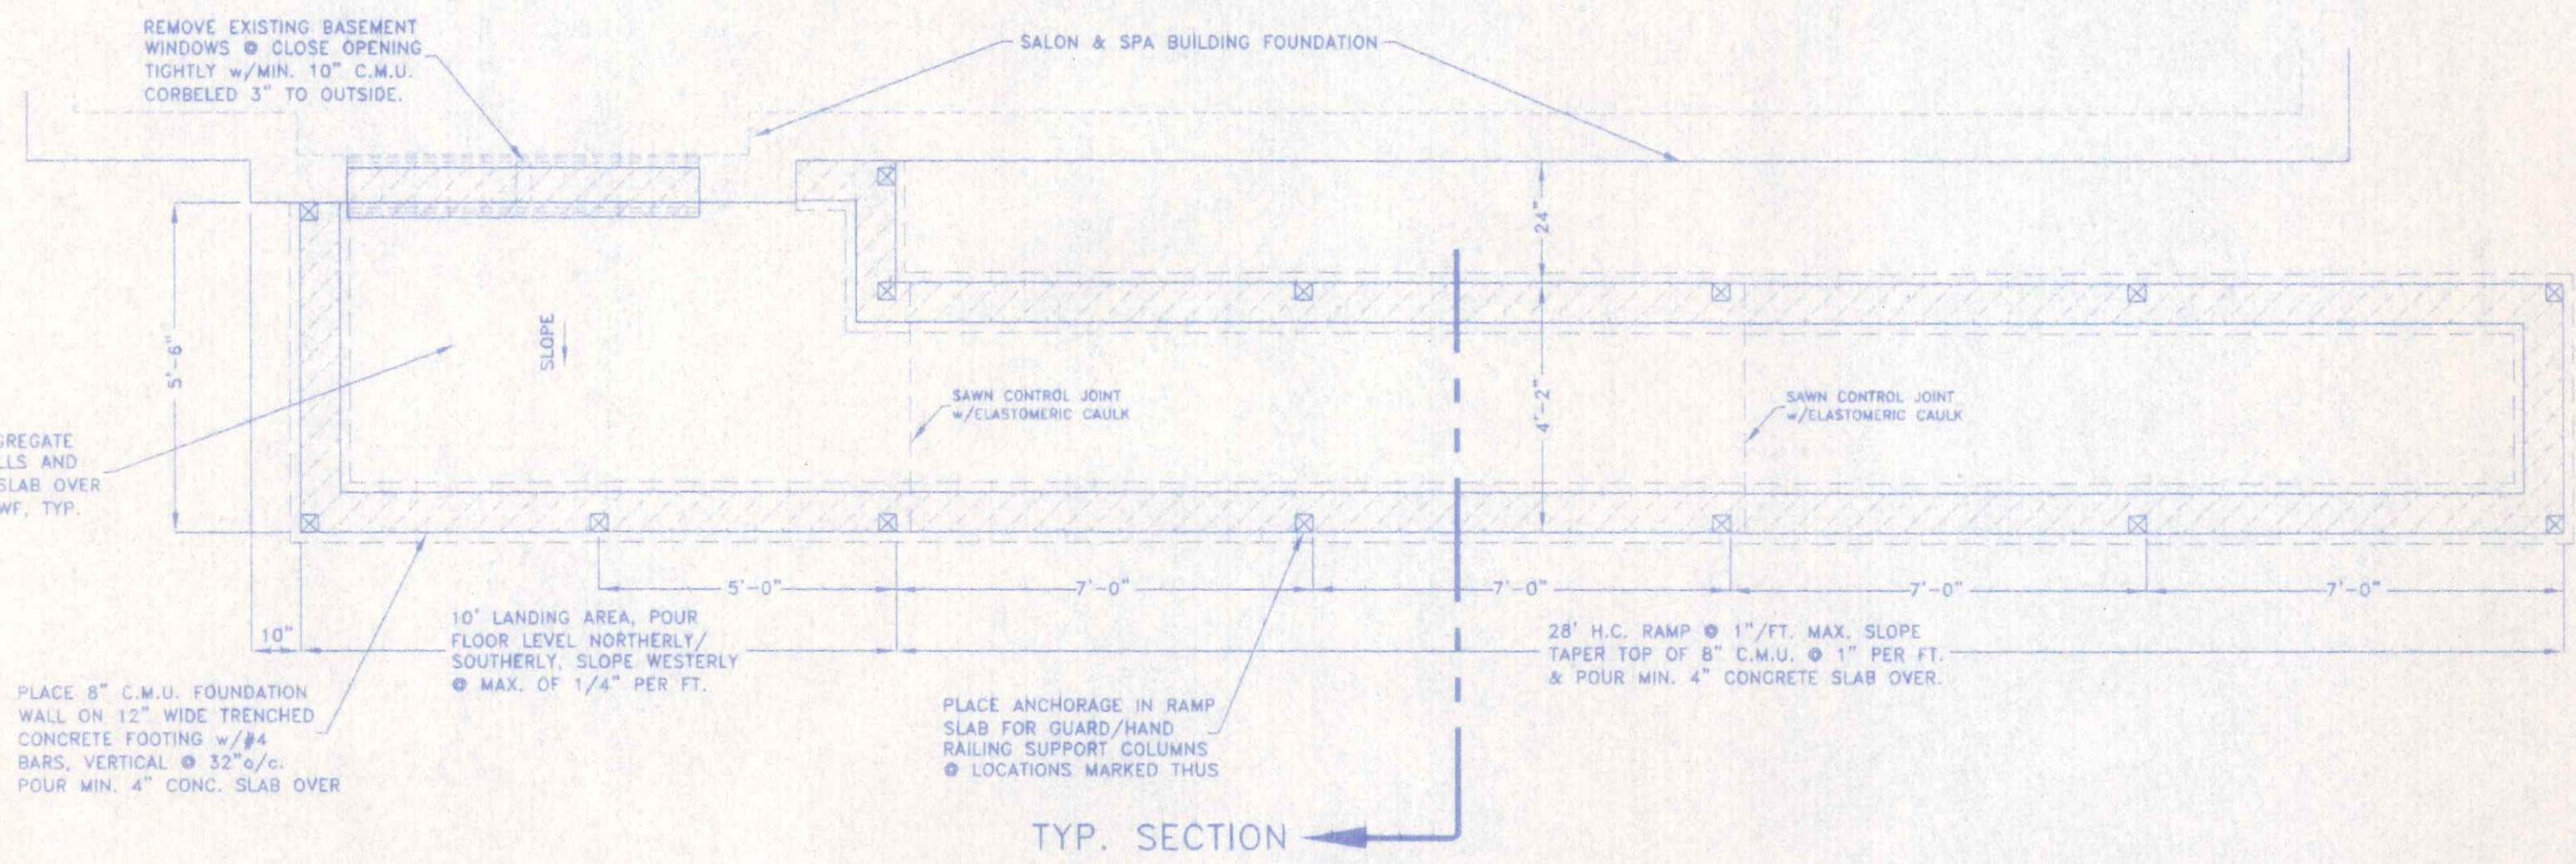

**TOPPER'S SALON & SPA**  
221 W. CLINTON STREET 419.438.7984 NAPOLÉON, OHIO

DIRECTORY: C:\ND\CUSTOM\DAMMAN SALON FILE NAME: FLRLELV REVISED: \_\_\_\_\_  
DRAWN BY: R.D.S. ~ dba: NEW DIMENSIONS

BUILDING ALTERATIONS; DETAILS; H.C. SCALE: NOTED  
RAMP, STAIRWAY & UTILITY SERVICES DATE: JULY 2010  
DRAWING NUMBER: 4 of 4